DETROIT RIVER AOC- SOUTH HENNEPIN MARSH HABITAT RESTORATION PROJECT

THE DETROIT RIVER, WAYNE COUNTY, MICHIGAN CONSTRUCTION DOCUMENTS - APRIL 2021

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GREAT LAKES RESTORATION INITIATIVE (GLRI) GRANT #NA19NMF4630266



PREPARED FOR FRIENDS OF THE DETROIT RIVER BY:














NOT TO SCALE

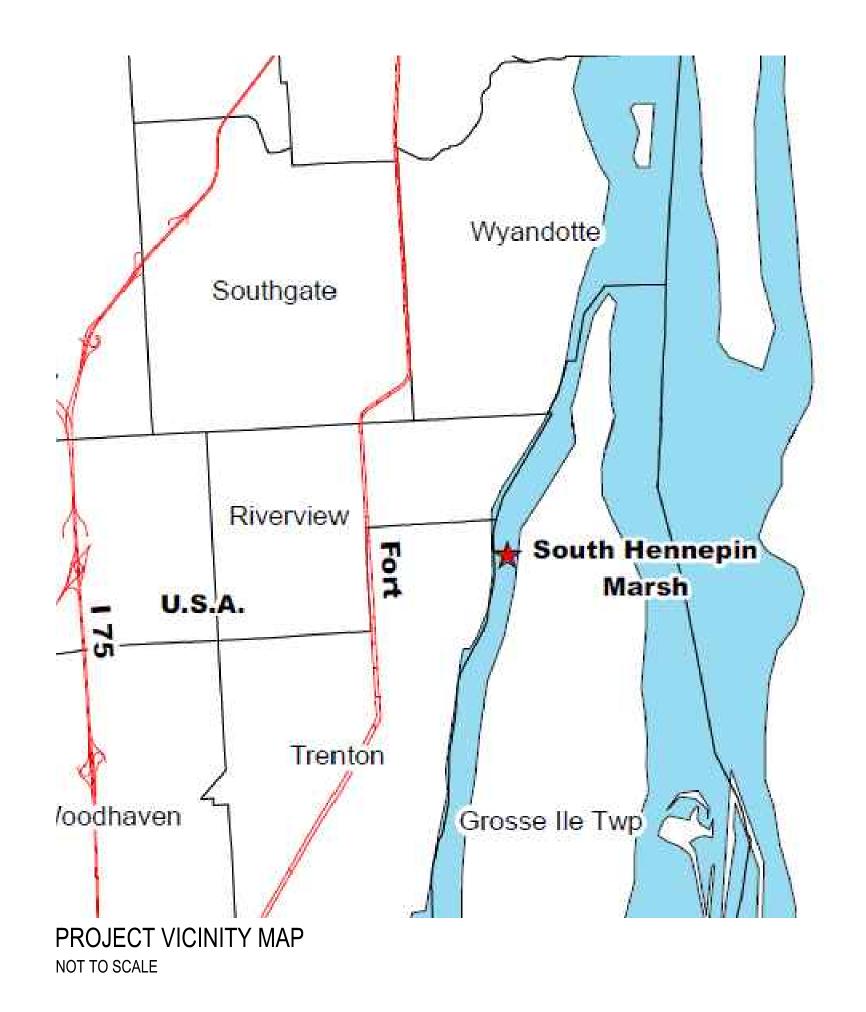

Canada

DRAWING INDEX

- 1. COVER SHEET
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- 0. REVEGETATION DETAILS



EXISTING CONDITIONS NOTES: THE CONTRACT DOCUMENTS REFLECT SURVEYS AND ELEVATIONS AT THE WORK AREA AS FOUND IN CONDITIONS SURVEYS MADE AS STATED ON THE DRAWINGS. THE CONDITIONS SHOWN ARE INDICATIVE OF THOSE THAT PREVAILED AT THE TIME OF THE SITE INVESTIGATIONS AND MAY BE DIFFERENT THAN THOSE AT THE TIME OF CONSTRUCTION. GENERAL LOCATIONS OF APPLICABLE EXISTING UTILITIES, VEGETATION, STRUCTURES, EQUIPMENT AND IMPROVEMENTS, BASED UPON LATEST INFORMATION AVAILABLE HAVE BEEN SHOWN ON THE DRAWINGS 2. UTILITY LINES, VEGETATION, STRUCTURES, EQUIPMENT OR IMPROVEMENTS SHALL BE PROTECTED FROM DAMAGE, AND IF DAMAGED, SHALL BE REPAIRED BY THE CONTRACTOR AT ITS OWN EXPENSE. THE WATER SURFACE ELEVATION AT THE TIME OF THE SURVEY WAS 574.2 AND IS SHOWN ON THE PROJECT DRAWINGS. WATER LEVELS HAVE FLUCTUATED SINCE THE - EX. BRUSH & TREES SURVEY WAS CONDUCTED. CONTRACTOR TO USE BEST AVAILABLE INFORMATION TO UNDERSTAND THE CONDITIONS OF THE WATER LEVELS. 4. SEE ALSO WATER LEVEL NOTES, THIS SHEET. 5. CONTRACTOR TO CONDUCT BATHYMETRIC SURVEY PRIOR TO CONSTRUCTION AND TO NOTIFY ENGINEER OF ANY SIGNIFICANT DIFFERENCES IN DATA FROM THAT WHICH IS mmmmm in in it SHOWN HERE. - Lucio SURVEY NOTES: HORIZONTAL DATUM IS ACCORDING TO MICHIGAN STATE PLANE COORDINATES, SOUTH ZONE (2113), INTERNATIONAL 570 FEET AS LINEAR UNIT OF MEASURE. VERTICAL DATUM IS ACCORDING TO THE NORTH AMERICAN VERTICAL DATUM OF 1988 (NAVD88), WITH PRIMARY BENCHMARKS AND DATUM CONVERSIONS LISTED HEREON. \Diamond THIS SURVEY DOES NOT CONSTITUTE A TITLE SEARCH BY THE SURVEYOR. ALL INFORMATION REGARDING LAND BOUNDARY, EASEMENTS, AND OTHER INFORMATION THAT S MAY AFFECT TITLE WAS GAINED FROM A CLIENT PROVIDED ALTA SURVEY, PROPERTY INFORMATION REFERENCE. NO UNDERGROUND UTILITIES WERE RESEARCHED AS PART OF THIS EFFORT. NO EXCAVATIONS WERE MADE AS PART OF THIS SURVEY TO LOCATE BURIED STRUCTURES AND OR UTILITIES. SUBSURFACE AND ENVIRONMENTAL CONDITIONS WERE NOT EXAMINED AND ARE NOT CONSIDERED A PART OF THIS SURVEY. NO STATEMENT IS MADE CONCERNING THE EXISTENCE OF UNDERGROUND OR OVERHEAD CONTAINERS EX. BRUSH & TREES OR FACILITIES THAT MAY AFFECT THE USE AND OR EXÍSTÍNG MÁRSH. DEVELOPMENT OF THIS SITE. LAND INACCESSIBLE MIDWESTERN CONSULTING PERFORMED A BATHYMETRIC SURVEY OF A PORTION OF THE DETROIT RIVER, ADJACENT TO SOUTH HENNEPIN MARSH, AS ILLUSTRATED HEREON. THE RESULTANT ONE-FOOT CONTOURS ARE BASED ON SOUNDINGS, COMBINED WITH SHORE TOPOGRAPHY COLLECTED USING GLOBAL POSITIONING RECEIVERS EDGE OF WATER REFERENCING THE MICHIGAN CONTINUOUSLY OPERATING **NOVEMBER 2018** REFERENCE SYSTEM (CORS) FOR PROJECT SITE CONTROL. DATUM CONVERSIONS: NAVD88 = IGLD85 + 0.27 FEET NAVD88 = NGVD29 - 0.56 FEET FLOODPLAIN NOTES: THE ENTIRETY OF SOUTH HENNEPIN LIES WITHIN FEMA FIRM ZONE AE, ACCORDING TO FEMA FIRM MAPS 26163C0413E. COMMUNITY 260227, PANEL NO. 416 OF 575, MAP REVISED FEBRUARY 2, 2012. THE FOLLOWING STATEMENTS APPLY: ZONE AE IS DEFINED AS "BASE FLOOD ELEVATIONS DETERMINED." FLOODWAY AREAS IN ZONE AE MUST BE KEPT FREE OF ENCROACHMENT SO THAT THE 1% ANNUAL CHANCE FLOOD CAN BE CARRIED WITHOUT SUBSTANTIAL INCREASES IN FLOOD HEIGHTS.

MERIDIAN RD.

\EXISTING CONDITIONS

EXIST. CONTOUR EDGE OF WATER (ON DATE OF FIELD WORK) EXIST. WATER MAIN EXIST. PARCEL BOUNDARY TREE OR BRUSH LIMIT INACCESSIBLE MARSH LAND F FOUND IRON PIPE FOUND P.K. FOUND IRON ROD

BASE SURVEY CONDUCTED BY MIDWESTERN CONSULTING, NOVEMBER 20, 2018

WATER ELEVATION AT TIME OF SURVEY = 574.2 (NAVD88 DATUM)

DATA COLLECTION:
GRID: STATEPLANE NAD83 (MI SOUTH 2113) INTERNATIONAL FEET
GPS: LEICA GS20 RTK
FATHOMETER: TELEDYNE EV 100 WITH 3 DEGREE TRANSDUCER

BENCHMARK SOUTH SURVEY:

T/IRON PIPE CP#5 LOCATED AT WATERS EDGE ON TAX PARCEL 75 006 01 0003 001

ELEVATION = 577.38 (NAVD88 DATUM)

THE CONTRACTOR UNDERSTANDS AND ACKNOWLEDGES THAT THE PERFORMANCE OF THE WORK IS REQUIRED WITHIN THE DETROIT RIVER SYSTEM AND FLOODPLAIN AND THAT THE DETROIT RIVER WATER LEVEL FLUCTUATES FREQUENTLY. THE CONTRACTOR UNDERSTANDS AND ACKNOWLEDGES THAT THEY HAVE TAKEN INTO ACCOUNT THE POTENTIAL FOR ANY WATER LEVEL CHANGES THAT MIGHT OCCUR IN COSTING AND PERFORMING THE CONTRACT WORK. THEREFORE, THE CONTRACTOR ACKNOWLEDGES THAT ANY FLUCTUATION IN WATER LEVELS DURING/OVER THE COURSE OF THE PROJECT WILL MOST LIKELY HAPPEN AND DOES NOT CONSTITUTE A CHANGE IN

CONDITIONS OR AN UNFORESEEN SITE CONDITION.

WNER: GROSSE ILE TOWNSHIP

EX. BUILDING

THE CONTRACTOR SHALL BE FULLY AWARE OF THE DETROIT RIVER HYDROLOGY AND CURRENT WEATHER CONDITIONS SO THAT WORK IN PROGRESS CAN BE SECURED AND PROTECTED, SO THAT SAFE JOB SITE WORKING CONDITIONS ARE MAINTAINED, AND SO THAT SOIL EROSION IS MINIMIZED.

THE CONTRACTOR ACKNOWLEDGES THAT DELAYS IN THE START OF, OR COMPLETION OF, WORK DUE TO FLUCTUATIONS IN THE WATER LEVEL THROUGHOUT THE DURATION OF THE PROJECT SHALL NOT CONSTITUTE A CHANGE IN CONDITIONS NOR SHALL BE A BASIS FOR ANY EXTENSION OF TIME OR DAMAGES. IF THE CONTRACTOR SHALL BE UNAVOIDABLY DELAYED IN BEGINNING OR FULFILLING THIS CONTRACT BY REASONS OF CHANGING WATER LEVELS, EXCESSIVE STORMS OR FLOODS, THE CONTRACTOR SHALL HAVE NO VALID CLAIM FOR DAMAGES, BUT IT SHALL IN SUCH CASE BE ENTITLED TO AN EXTENSION OF TIME AS THE ENGINEER SHALL ADJUDGE TO BE JUST AND REASONABLE, PROVIDED THAT FORMAL CLAIM FOR AN EXTENSION OF TIME IS MADE IN WRITING BY THE CONTRACTOR WITHIN ONE WEEK OF THE ALLEGED DELAY.

Environmer Consulting & Technology, I 2200 Commonwealth Blvd, Suite 300 Ann Arbor, Michigan 48105 734.769.3004 734.769.3164 fax www.ectinc.com










AOCSOUTH
HENNEPIN
MARSH HABITAT
RESTORATION
PROJECT

FRIENDS OF THE DETROIT RIVER

WAYNE COUNTY, MICHIGAN

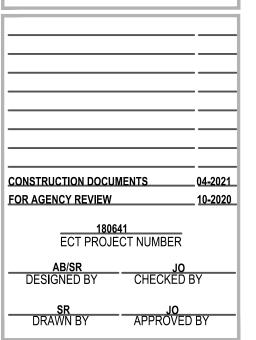

-VICTING

SHEET TITLE

EXISTING CONDITIONS

SCALE: 1" = 100' @ 22" x 34" 0 50' 100' 2

NORTH



SIGN DIMENSIONS: 1200 mm x 2400 mm x 19 mm (approx. 4' x 8' x 3/4")
VINYL, PLASTIC, OR SIMILAR MATERIAL AS APPROVED
BY ENGINEER PRIOR TO FABRICATION

SIGN NOTES:

- 1. SIGN LOCATION TO BE DETERMINED WITH ENGINEER PRIOR TO CONSTRUCTION.
- 2. CONTRACTOR TO CONFIRM DOLLAR AMOUNTS PRIOR TO CONSTRUCTION.

SITE CLEARING NOTES:

1. TOTAL SITE CLEARING AREA: 0.3 ACRES

SCHEDULING NOTES


1. DUE TO FISH SPAWNING AND MIGRATION, NO IN-STREAM WORK SHALL OCCUR BETWEEN MARCH 15 AND JUNE 15.

TREE REMOVAL NOTES

- 1. ALL TREES TO BE REMOVED AND ALL CLEARING TO BE FIELD VERIFIED BY ENGINEER PRIOR TO WORK ACTIVITIES.
- 2. ALL EXCESS WOODY DEBRIS TO BE DISPOSED OF LEGALLY OFFSITE.
- 3. ANY MERCHANTABLE TIMBER MAY BE CONSIDERED PROPERTY OF THE CONTRACTOR.

FLOODPLAIN NOTE:

THE CONTRACTOR UNDERSTANDS AND ACKNOWLEDGES THAT THE PERFORMANCE OF WORK IS REQUIRED WITHIN THE DETROIT RIVER SYSTEM AND FLOODPLAIN AND THAT THE DETROIT RIVER WATER LEVEL FLUCTUATES FREQUENTLY. THE CONTRACTOR UNDERSTANDS AND ACKNOWLEDGES THAT THEY HAVE TAKEN INTO ACCOUNT THE POTENTIAL FOR ANY WATER LEVEL CHANGES THAT MIGHT OCCUR IN COSTING AND PERFORMING THE CONTRACT WORK. THEREFORE, THE CONTRACTOR ACKNOWLEDGES THAT ANY FLUCTUATION IN WATER LEVELS DURING/OVER THE COURSE OF THE PROJECT WILL MOST LIKELY HAPPEN AND DOES NOT CONSTITUTE A CHANGE IN CONDITIONS OR UNFORESEEN SITE CONDITION.

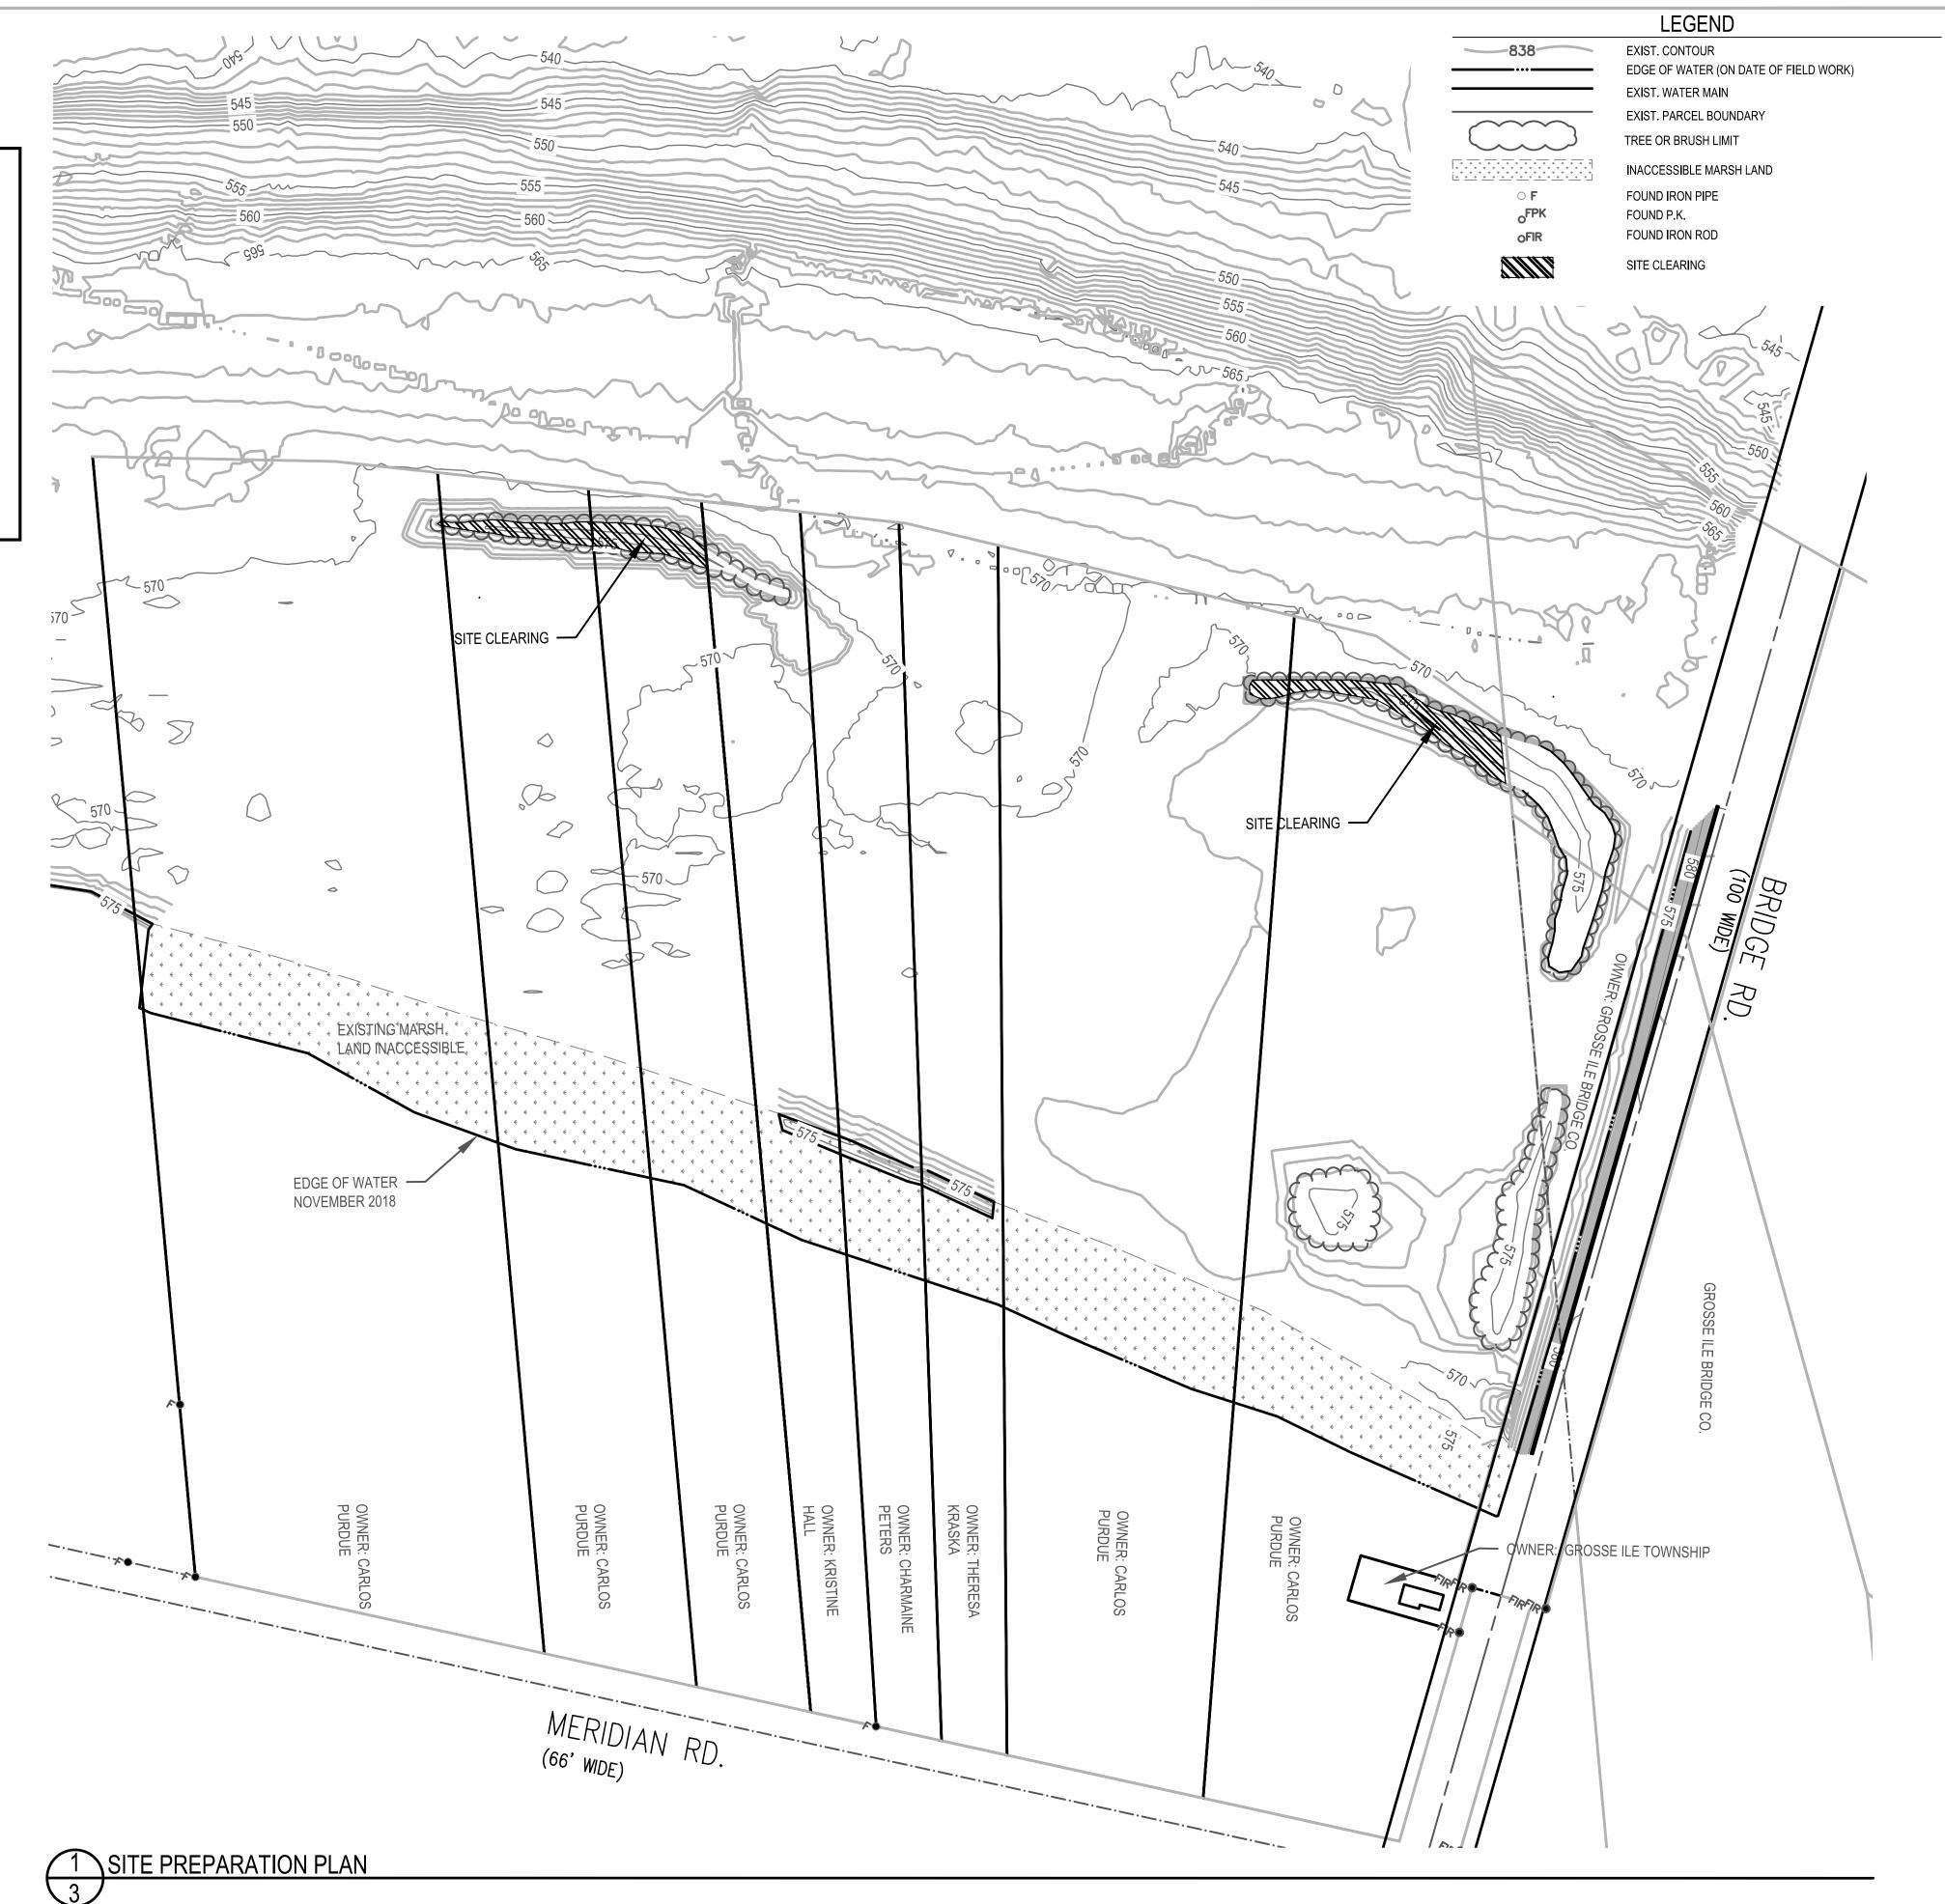

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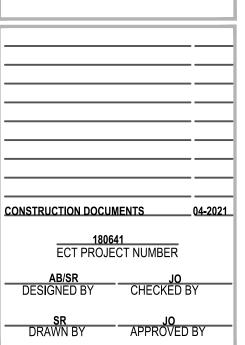




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FRIENDS OF THE DETROIT RIVER


WAYNE COUNTY, MICHIGAN



SHEET TITLE

SITE

PREPARATION PLAN

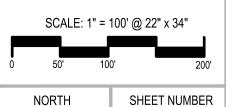

NORTH

2

1. ALL WORK TO BE PERFORMED IN ACCORDANCE WITH THE EGLE AND USACE PERMITS, AND ALL OTHER PERMITS TO BE ISSUED FOR THIS PROJECT. PERMITS HAVE BEEN APPLIED FOR, BUT HAVE NOT BEEN ISSUED YET. A COPY OF THE PERMIT WILL BE PROVIDED TO THE CONTRACTOR ONCE RECEIVED.

STAGING AND ACCESS NOTES


1. THE PROJECT TO BE ACCESSED AND CONSTRUCTED VIA THE RIVER. NO STAGING OR ACCESS ON THE ISLAND.

TURBIDITY CONTROL NOTES

1. NO WORK OR DREDGING WITHIN THE WATER IS ALLOWED FROM MAY 1 THROUGH JULY 30 WITHOUT THE USE OF A TURBIDITY CURTAIN/ CONTAINMENT. THIS RESTRICTION DOES NOT APPLY TO THE PLACEMENT OF CLEAN ROCK AND GRAVEL.

2. WHEN REQUIRED, USE TURBIDITY CURTAIN TO ENCLOSE THE WORK AREA ENTIRELY. CURTAIN TO BE INSTALLED TO EXTEND FROM THE BED OF THE WATER BODY TO A POINT ABOVE THE EXISTING WATER'S SURFACE.

3. WHEN USED, TURBIDITY CURTAIN TO BE MAINTAINED FOR THE DURATION OF THE PROJECT AND LEFT IN PLACE AFTER COMPLETION OF DREDGING UNTIL ALL DISTURBED SEDIMENTS HAVE SETTLED. AT APPROPRIATE TIME, TURBIDITY CURTAIN SHALL BE REMOVED.

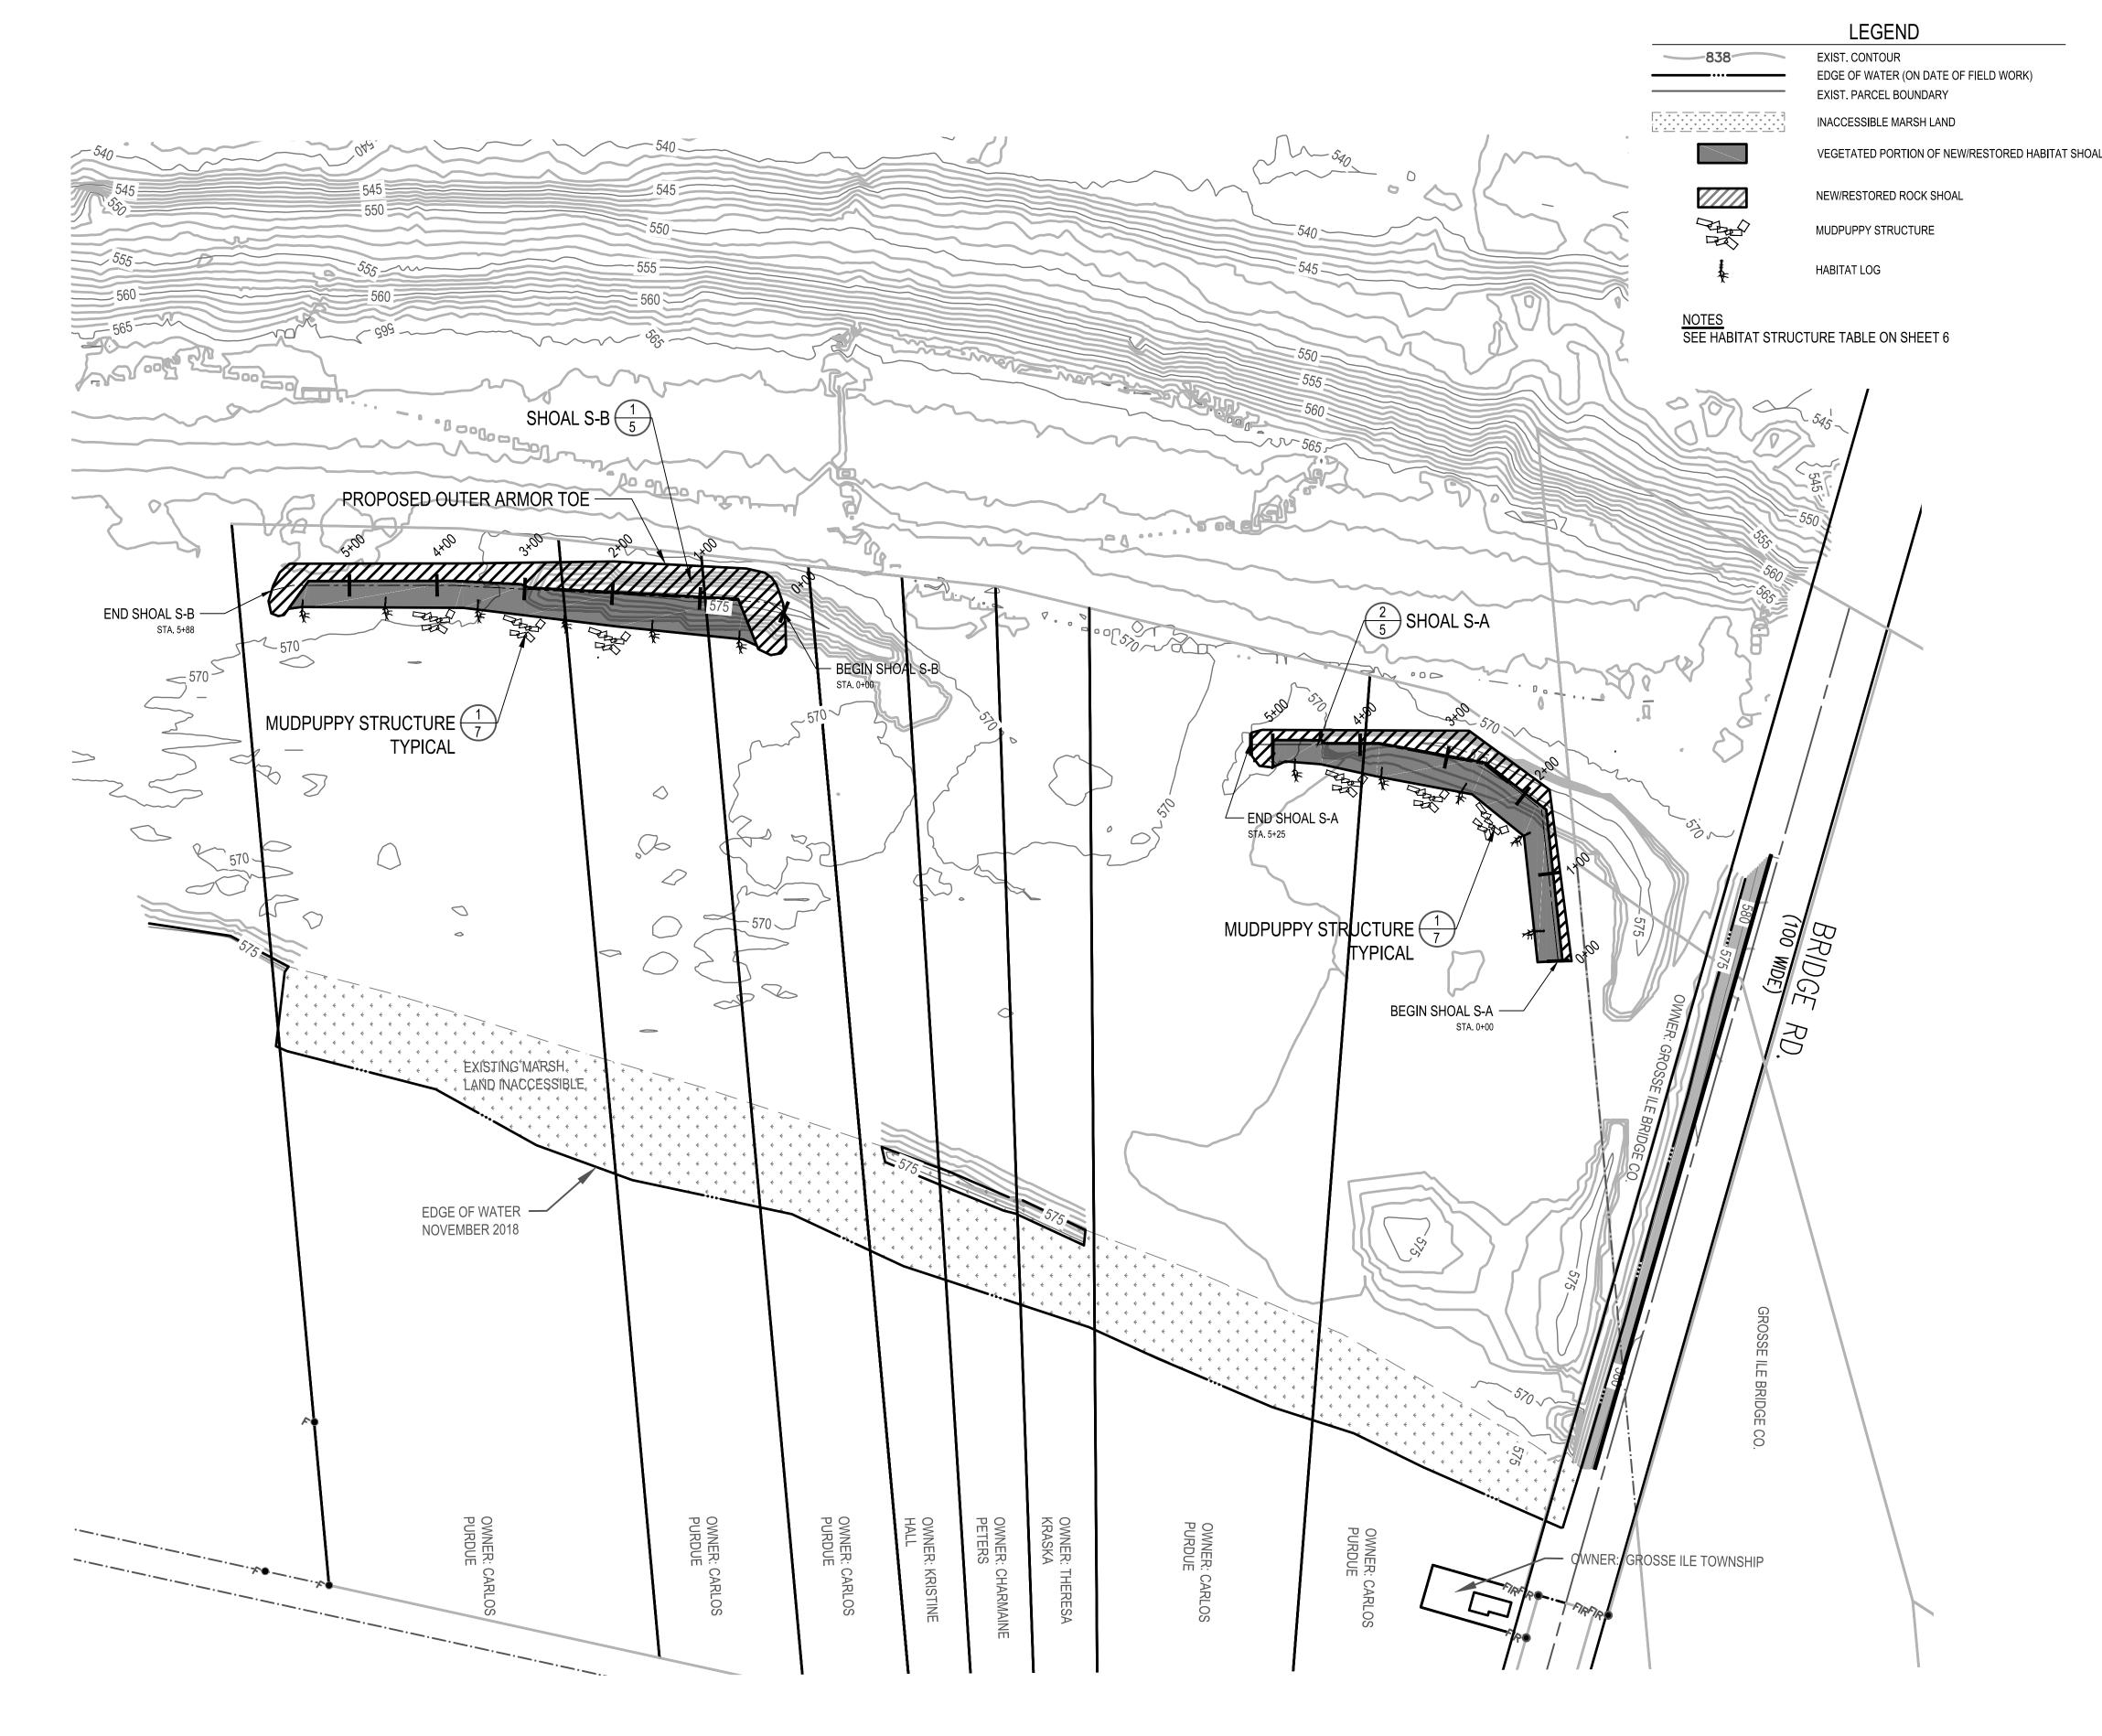













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FRIENDS OF THE DETROIT RIVER


WAYNE COUNTY, MICHIGAN

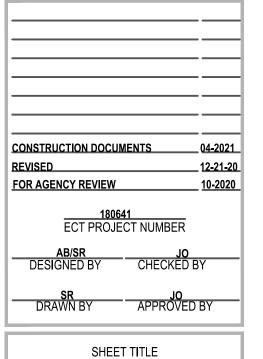

PROPOSED CONDITIONS -OVERALL



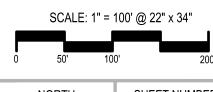

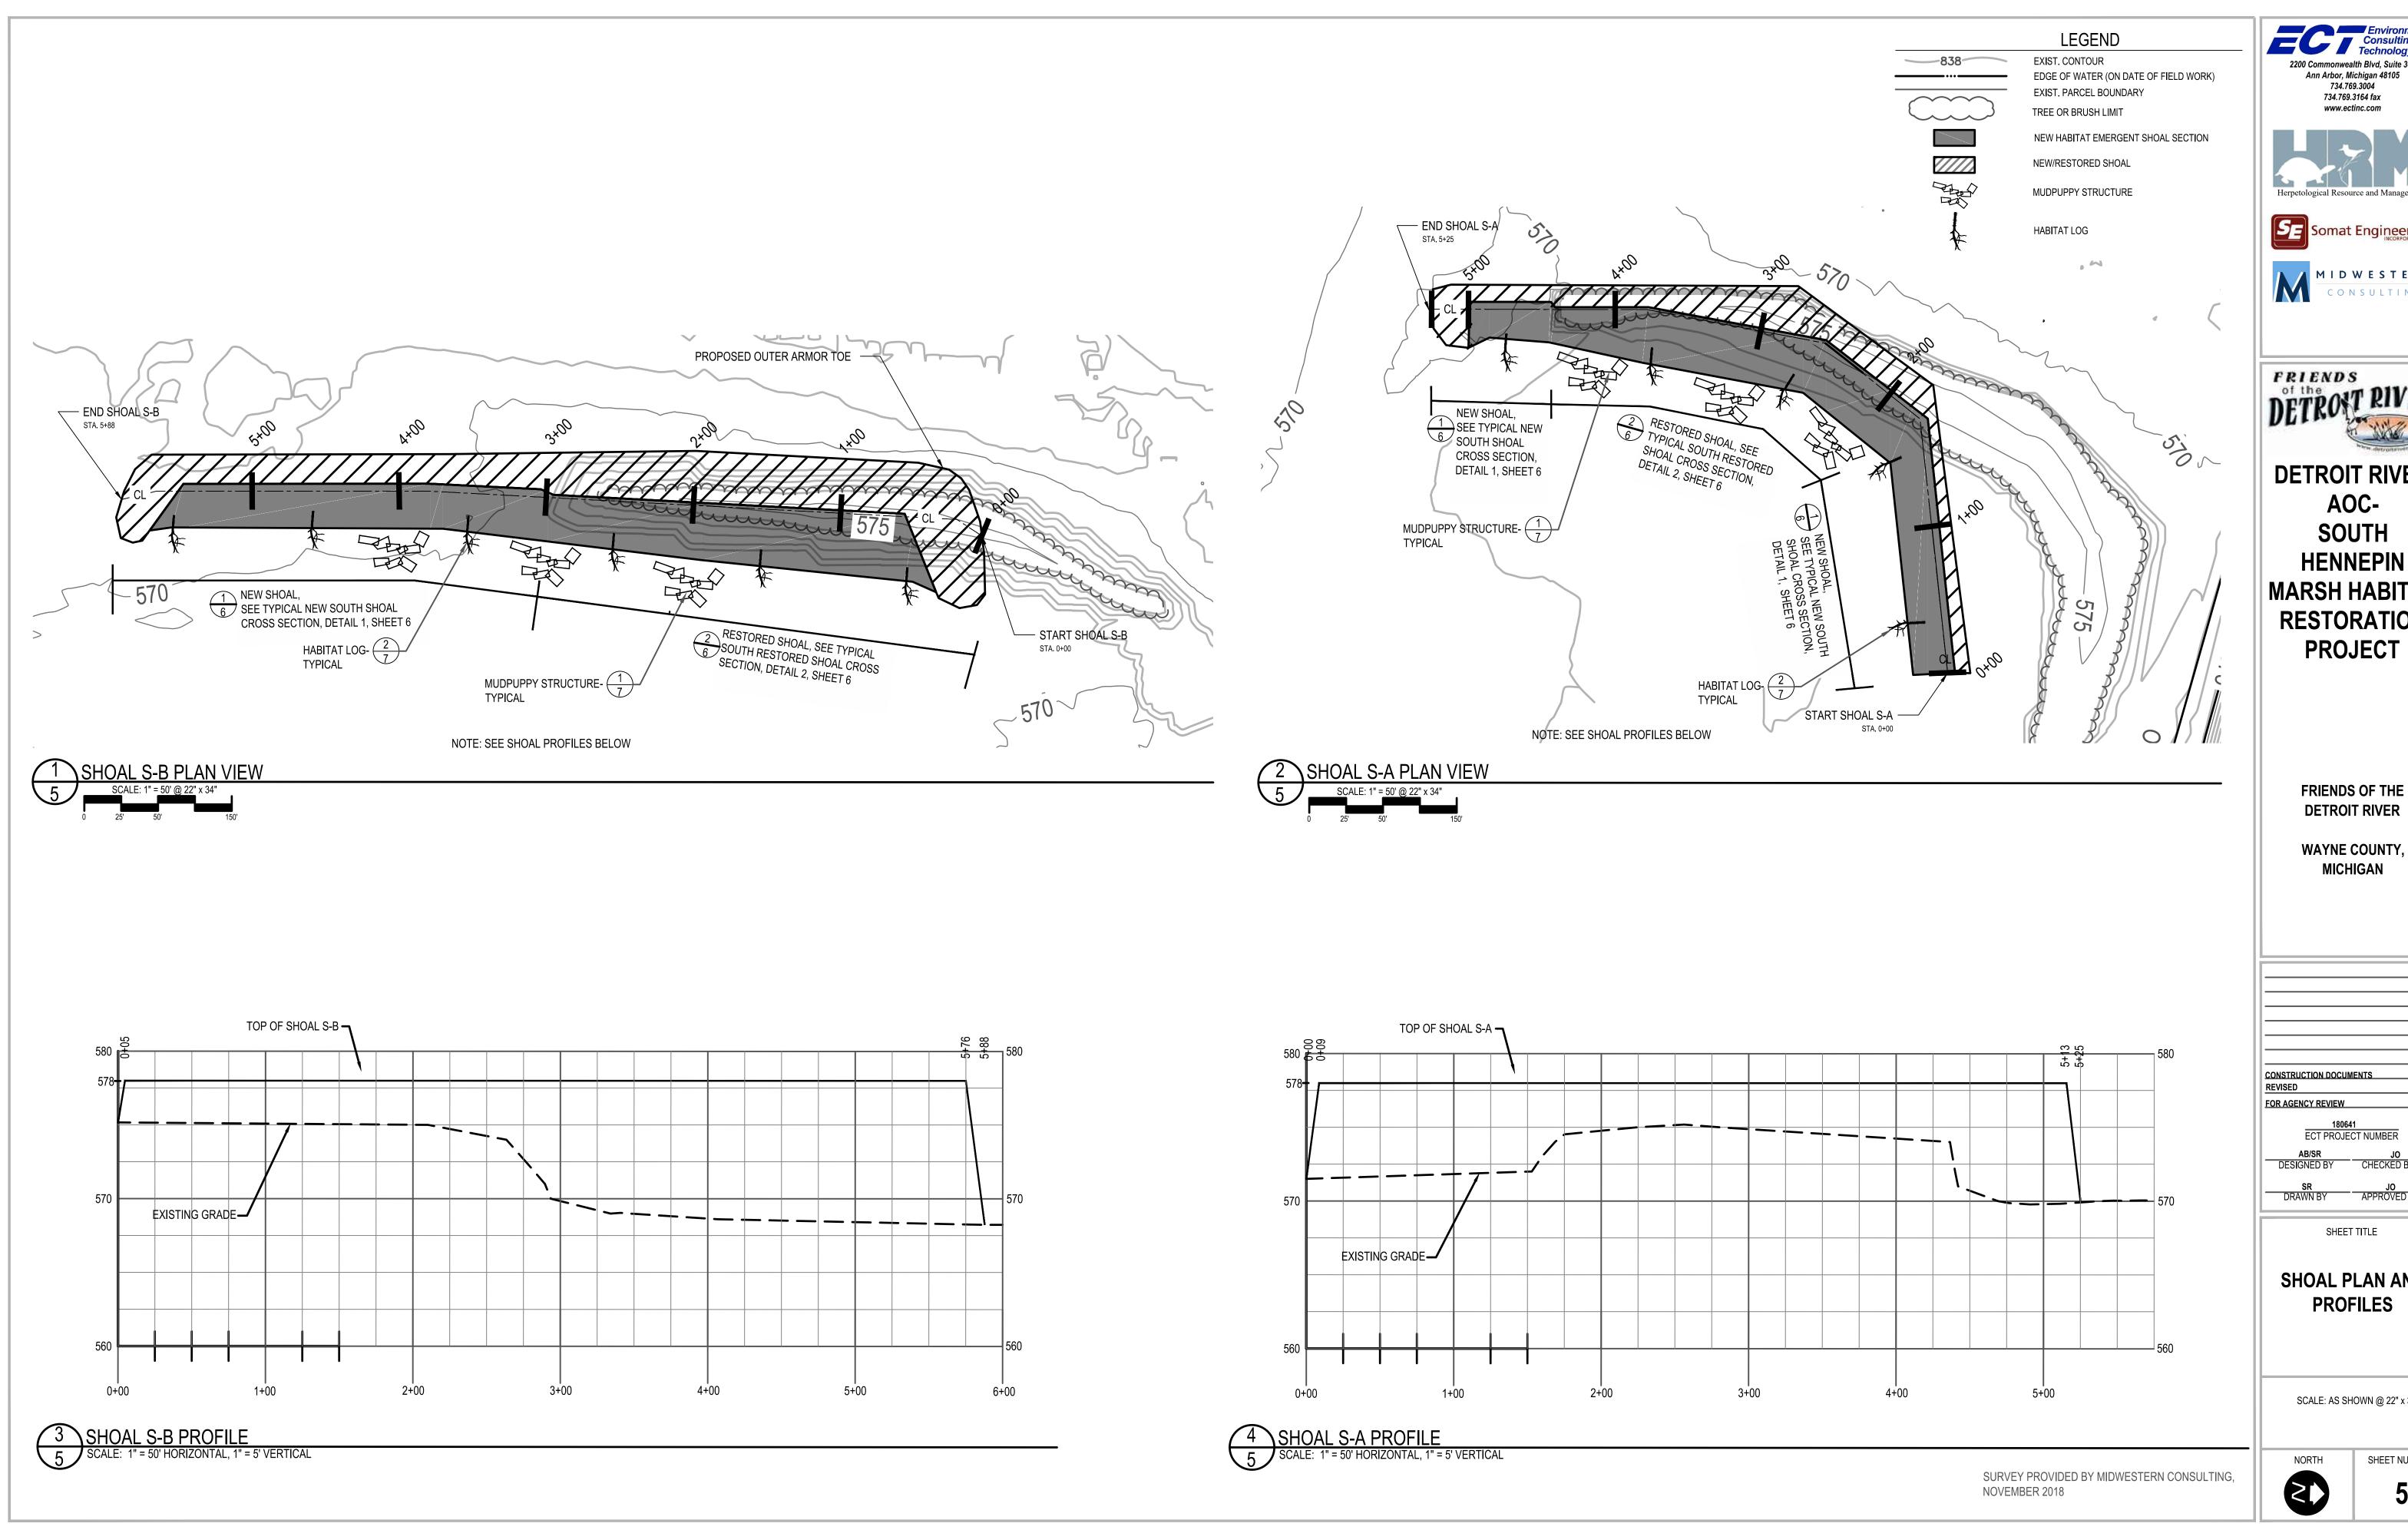

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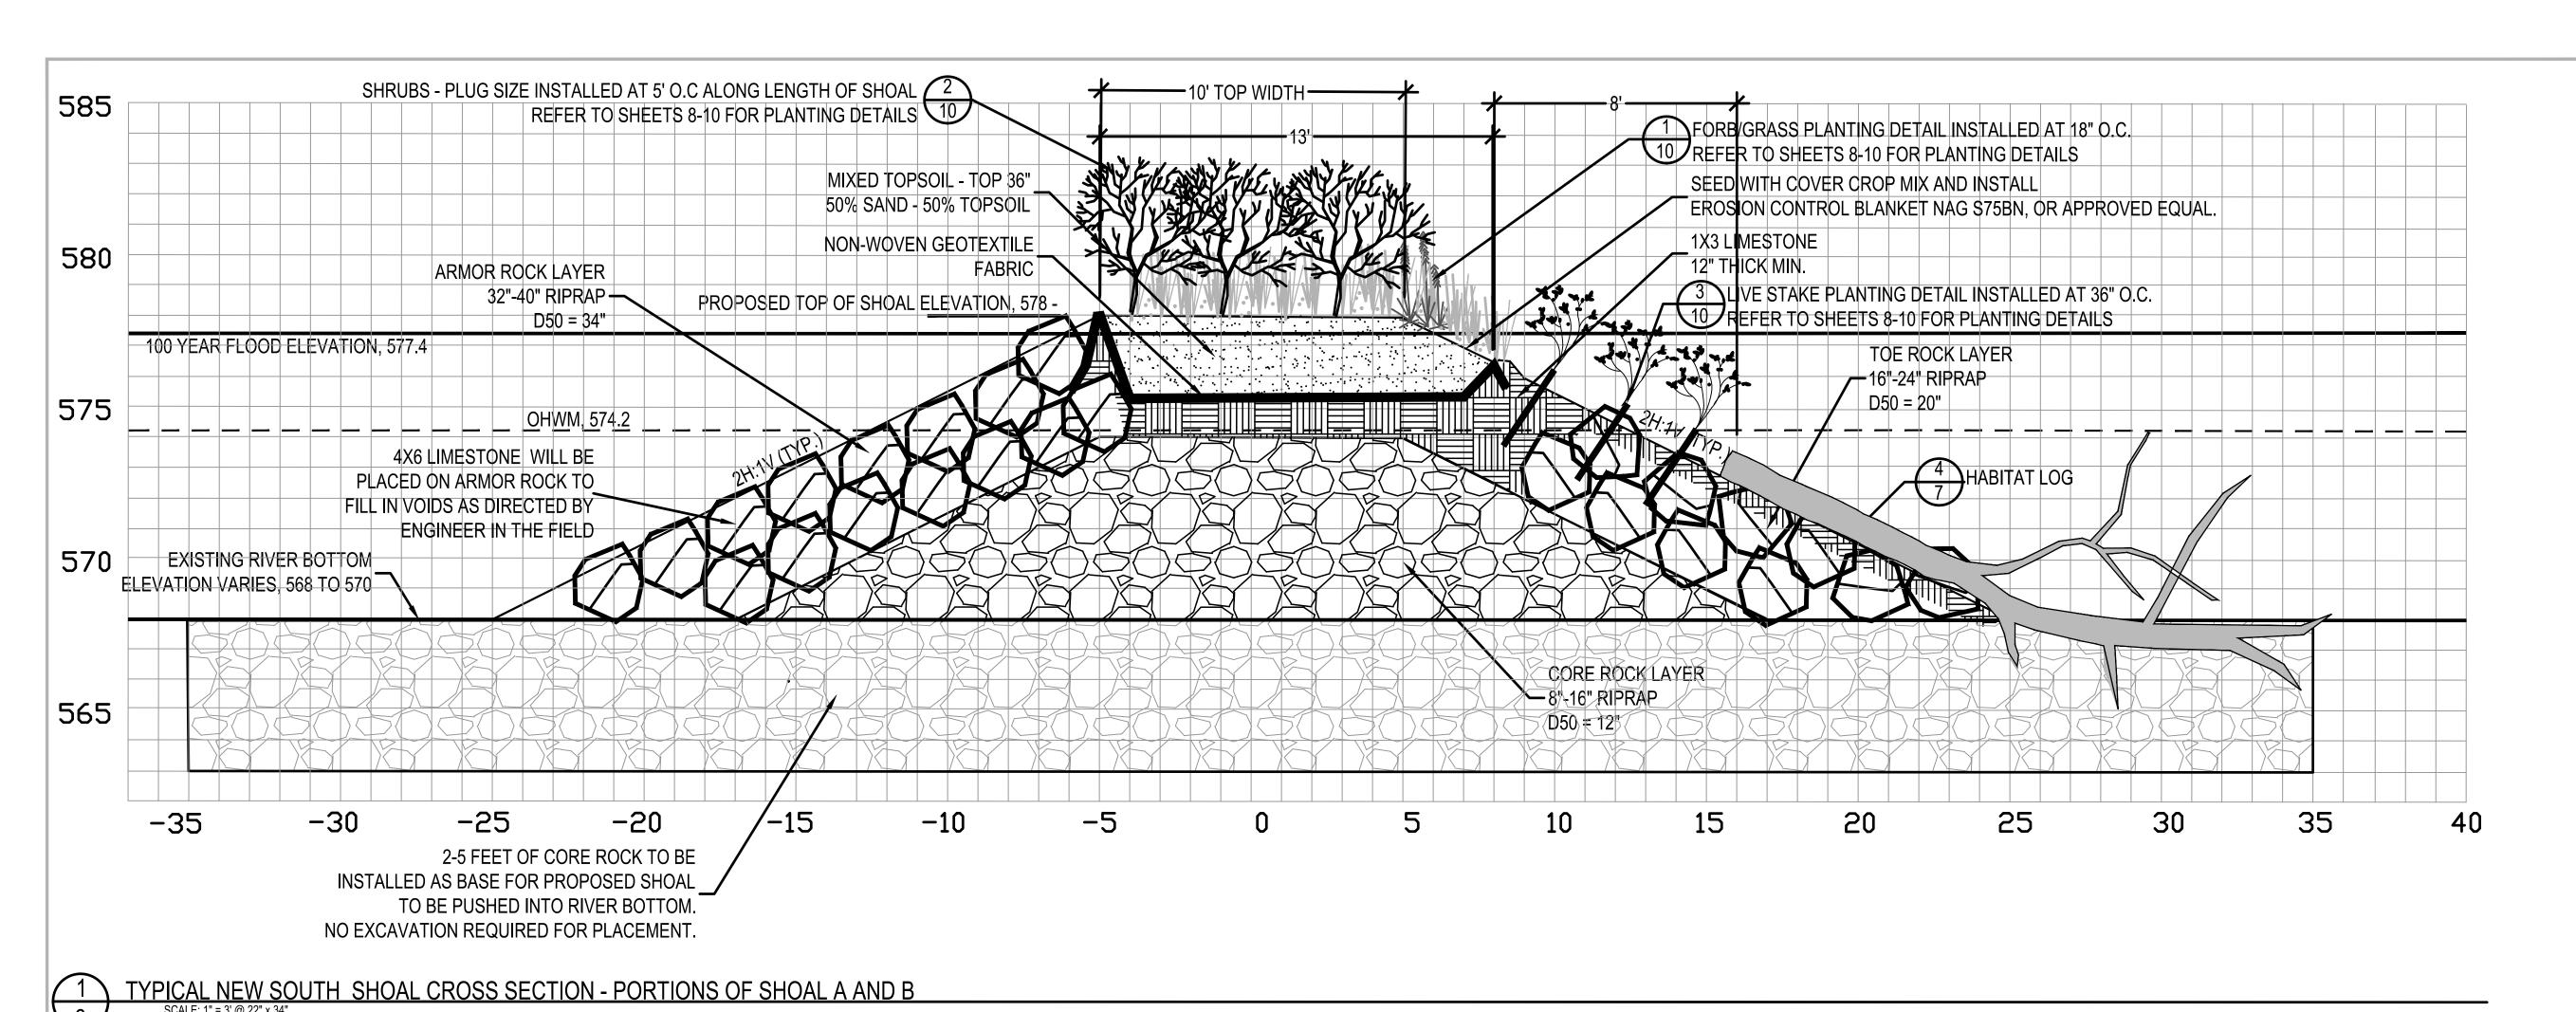
DETROIT RIVER HENNEPIN MARSH HABITAT **RESTORATION PROJECT**


> FRIENDS OF THE **DETROIT RIVER**

180641 ECT PROJECT NUMBER

SHOAL PLAN AND PROFILES

SCALE: AS SHOWN @ 22" x 34"



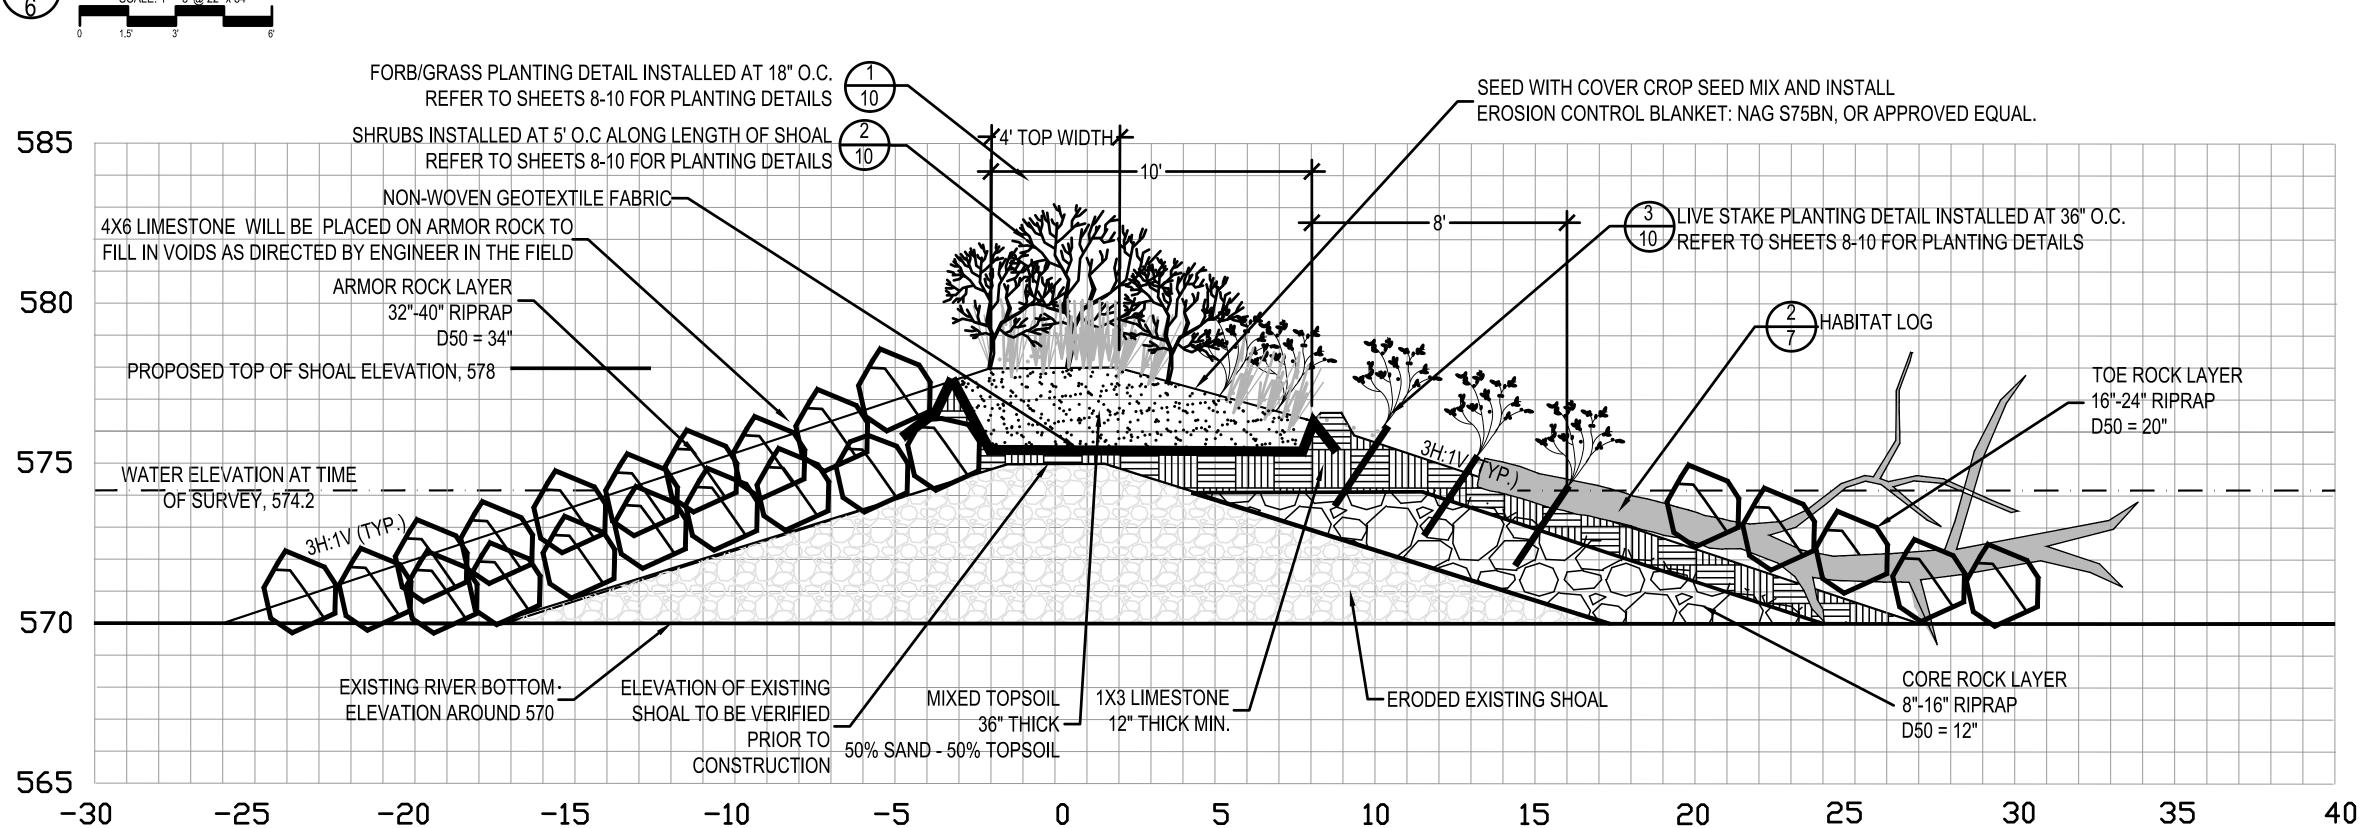

2 TYPICAL SOUTH RESTORED SHOAL CROSS SECTION - PORTIONS OF SHOAL A AND B

PROPOSED HABITAT STRUCTURE TABLE:

	OCE HABITAT O	IABITAT STREETINE TAE				
SHOAL -TYPICAL	HABITAT LOGS AT SHOAL	SINGLE MUDPUPPY STRUCTURE AT SHOAL				
10 A	0+75	2+00				
D SI	1+25	3+00				
PROPOSED	1+75	4+00				
OP(2+25					
PR	2+75					
	3+25					

ROCK TOLERANCE: NO MORE THAN 10% OF THE RIPRAP QUANTITY SHALL EXCEED THE MAXIMUM RIPRAP SIZE AND NO MORE THAN 10% OF THE RIPRAP QUANTITY SHALL BE SMALLER THAN THE MINIMUM RIPRAP SIZE. THE LARGEST ROCK DIMENSION SHALL BE NO MORE THAN 1.5 TIMES THE SPECIFIED D50.

SURVEY PROVIDED BY MIDWESTERN CONSULTING, NOVEMBER 2018

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RESTORATION
PROJECT

FRIENDS OF THE DETROIT RIVER

WAYNE COUNTY, MICHIGAN

CONSTRUCTION DOCUMENTS
REVISED
12-21-2
FOR AGENCY REVIEW
10-202

180641
ECT PROJECT NUMBER
AB/SR
DESIGNED BY
CHECKED BY


SHEET TITLE

SHOAL SECTIONS

SCALE: AS SHOWN @ 22" x 34"

NORTH SHE



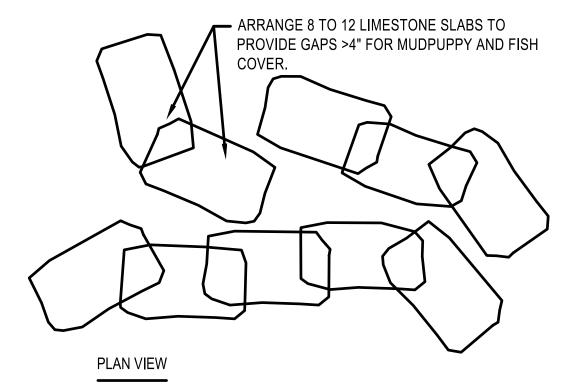

ARRANGE 8 TO 12 LIMESTONE SLABS TO
PROVIDE GAPS >4" FOR MUDPUPPY AND
FISH COVER.


1'X2'X2" LIMESTONE SLABS, TYP.

RIVER BOTTOM

MUDPUPPY STRUCTURE DETAIL

NOTES

- GROUPINGS OF 8 TO 12 STONE SLABS SHOULD BE PLACED.
- PLACEMENT OF MUDPUPPY AND FISH COVER STRUCTURE TO BE DETERMINED ON SITE BY WILDLIFE BIOLOGIST.
- CARE SHALL BE TAKEN DURING PLACEMENT TO AVOID HIGH QUALITY AQUATIC VEGETATION.
- MUDPUPPY AND FISH COVER STRUCTURES SHOULD BE PLACED IN NEARSHORE.
- 5 DO NOT STACK STONES MORE THAN 2 HIGH.

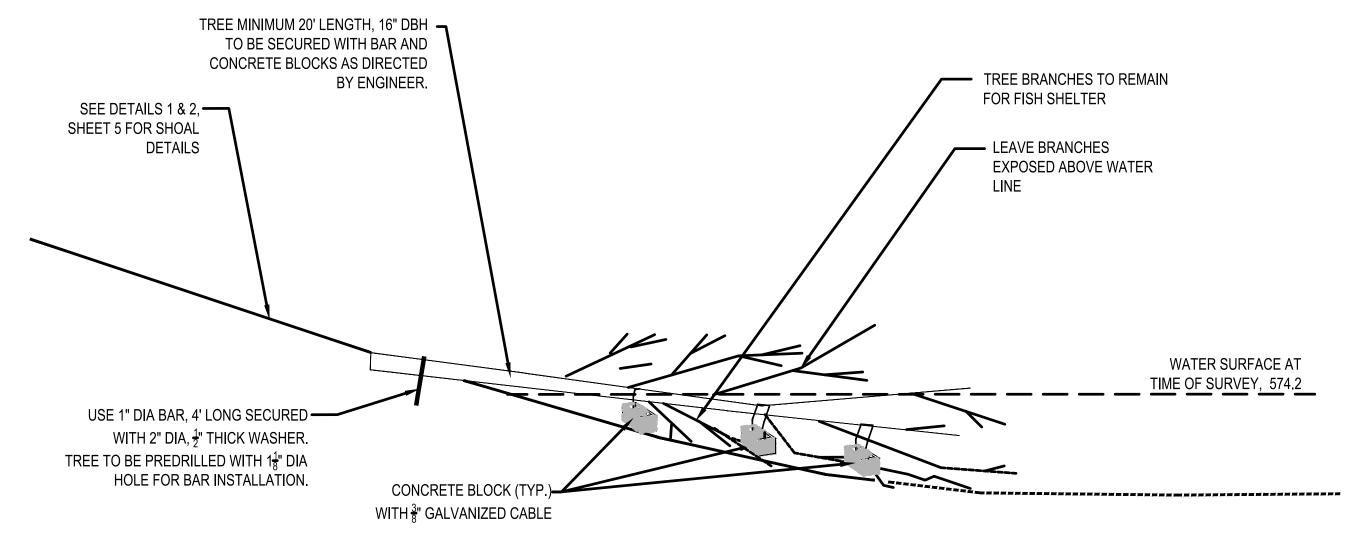













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FRIENDS OF THE DETROIT RIVER

WAYNE COUNTY, MICHIGAN

CONSTRUCTION DOCUMENTS 04-2021
REVISED 12-21-20
FOR AGENCY REVIEW 10-2020

180641
ECT PROJECT NUMBER


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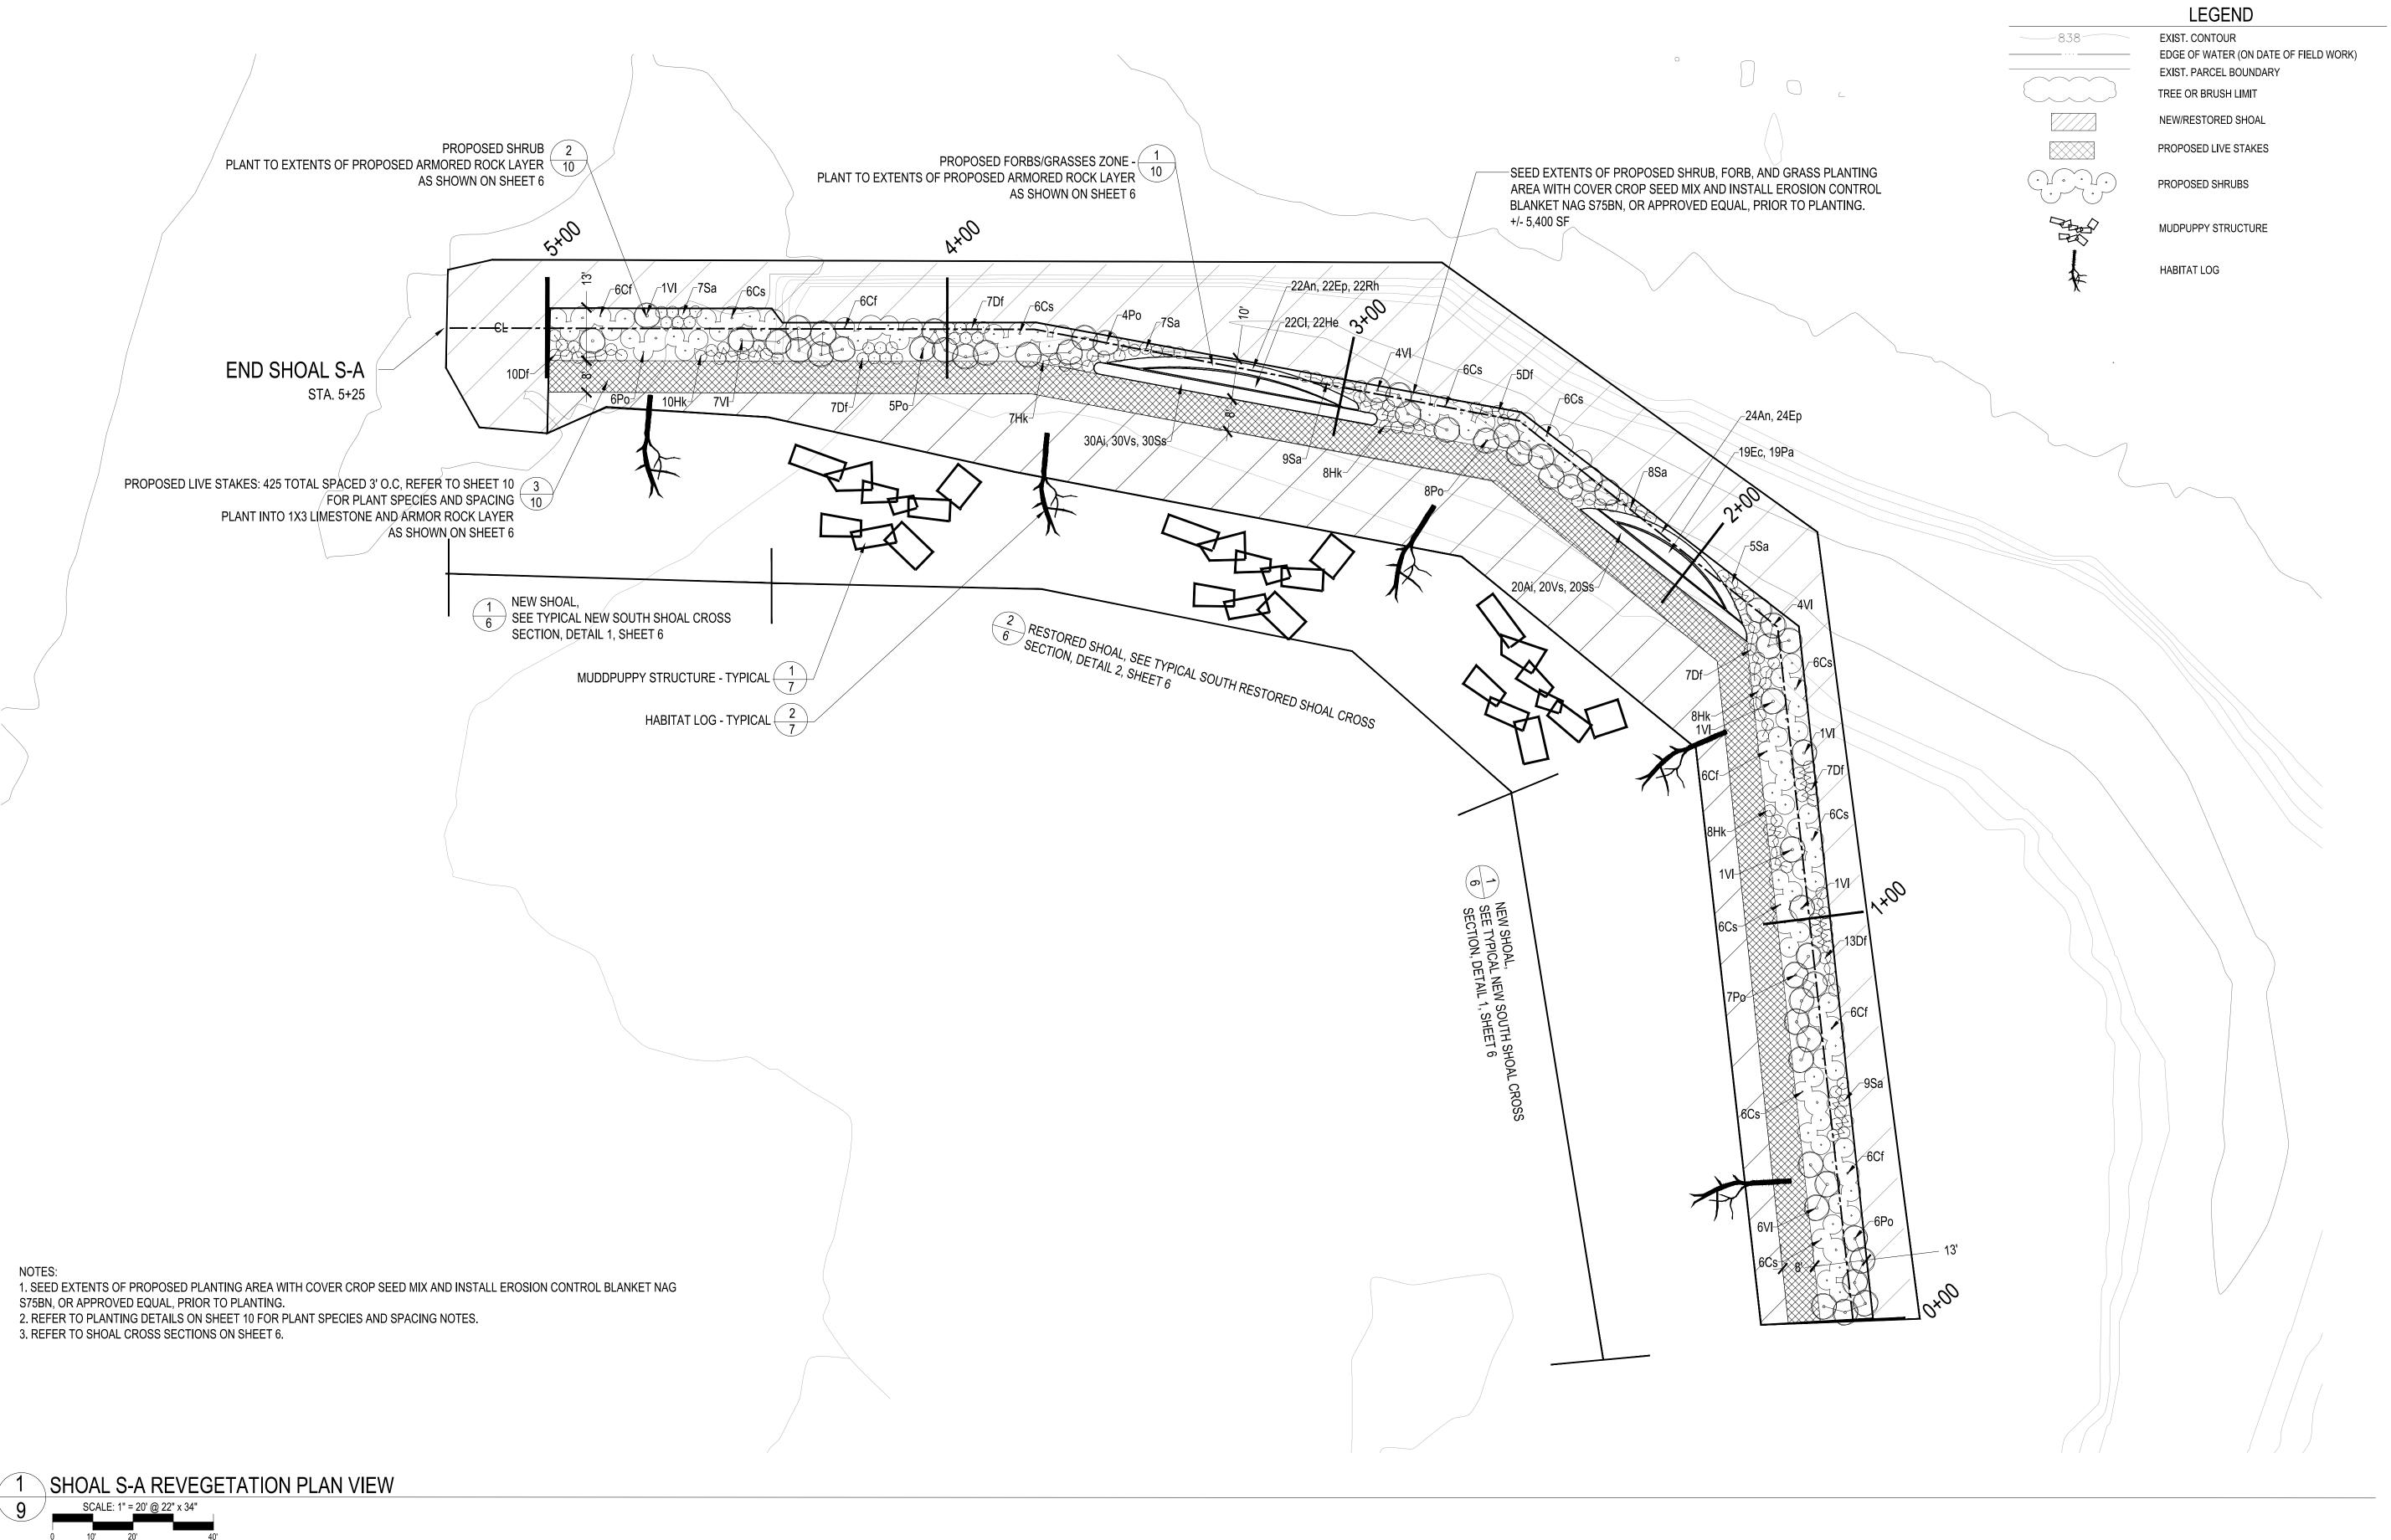
DETAILS

SHEET NUMBER

7





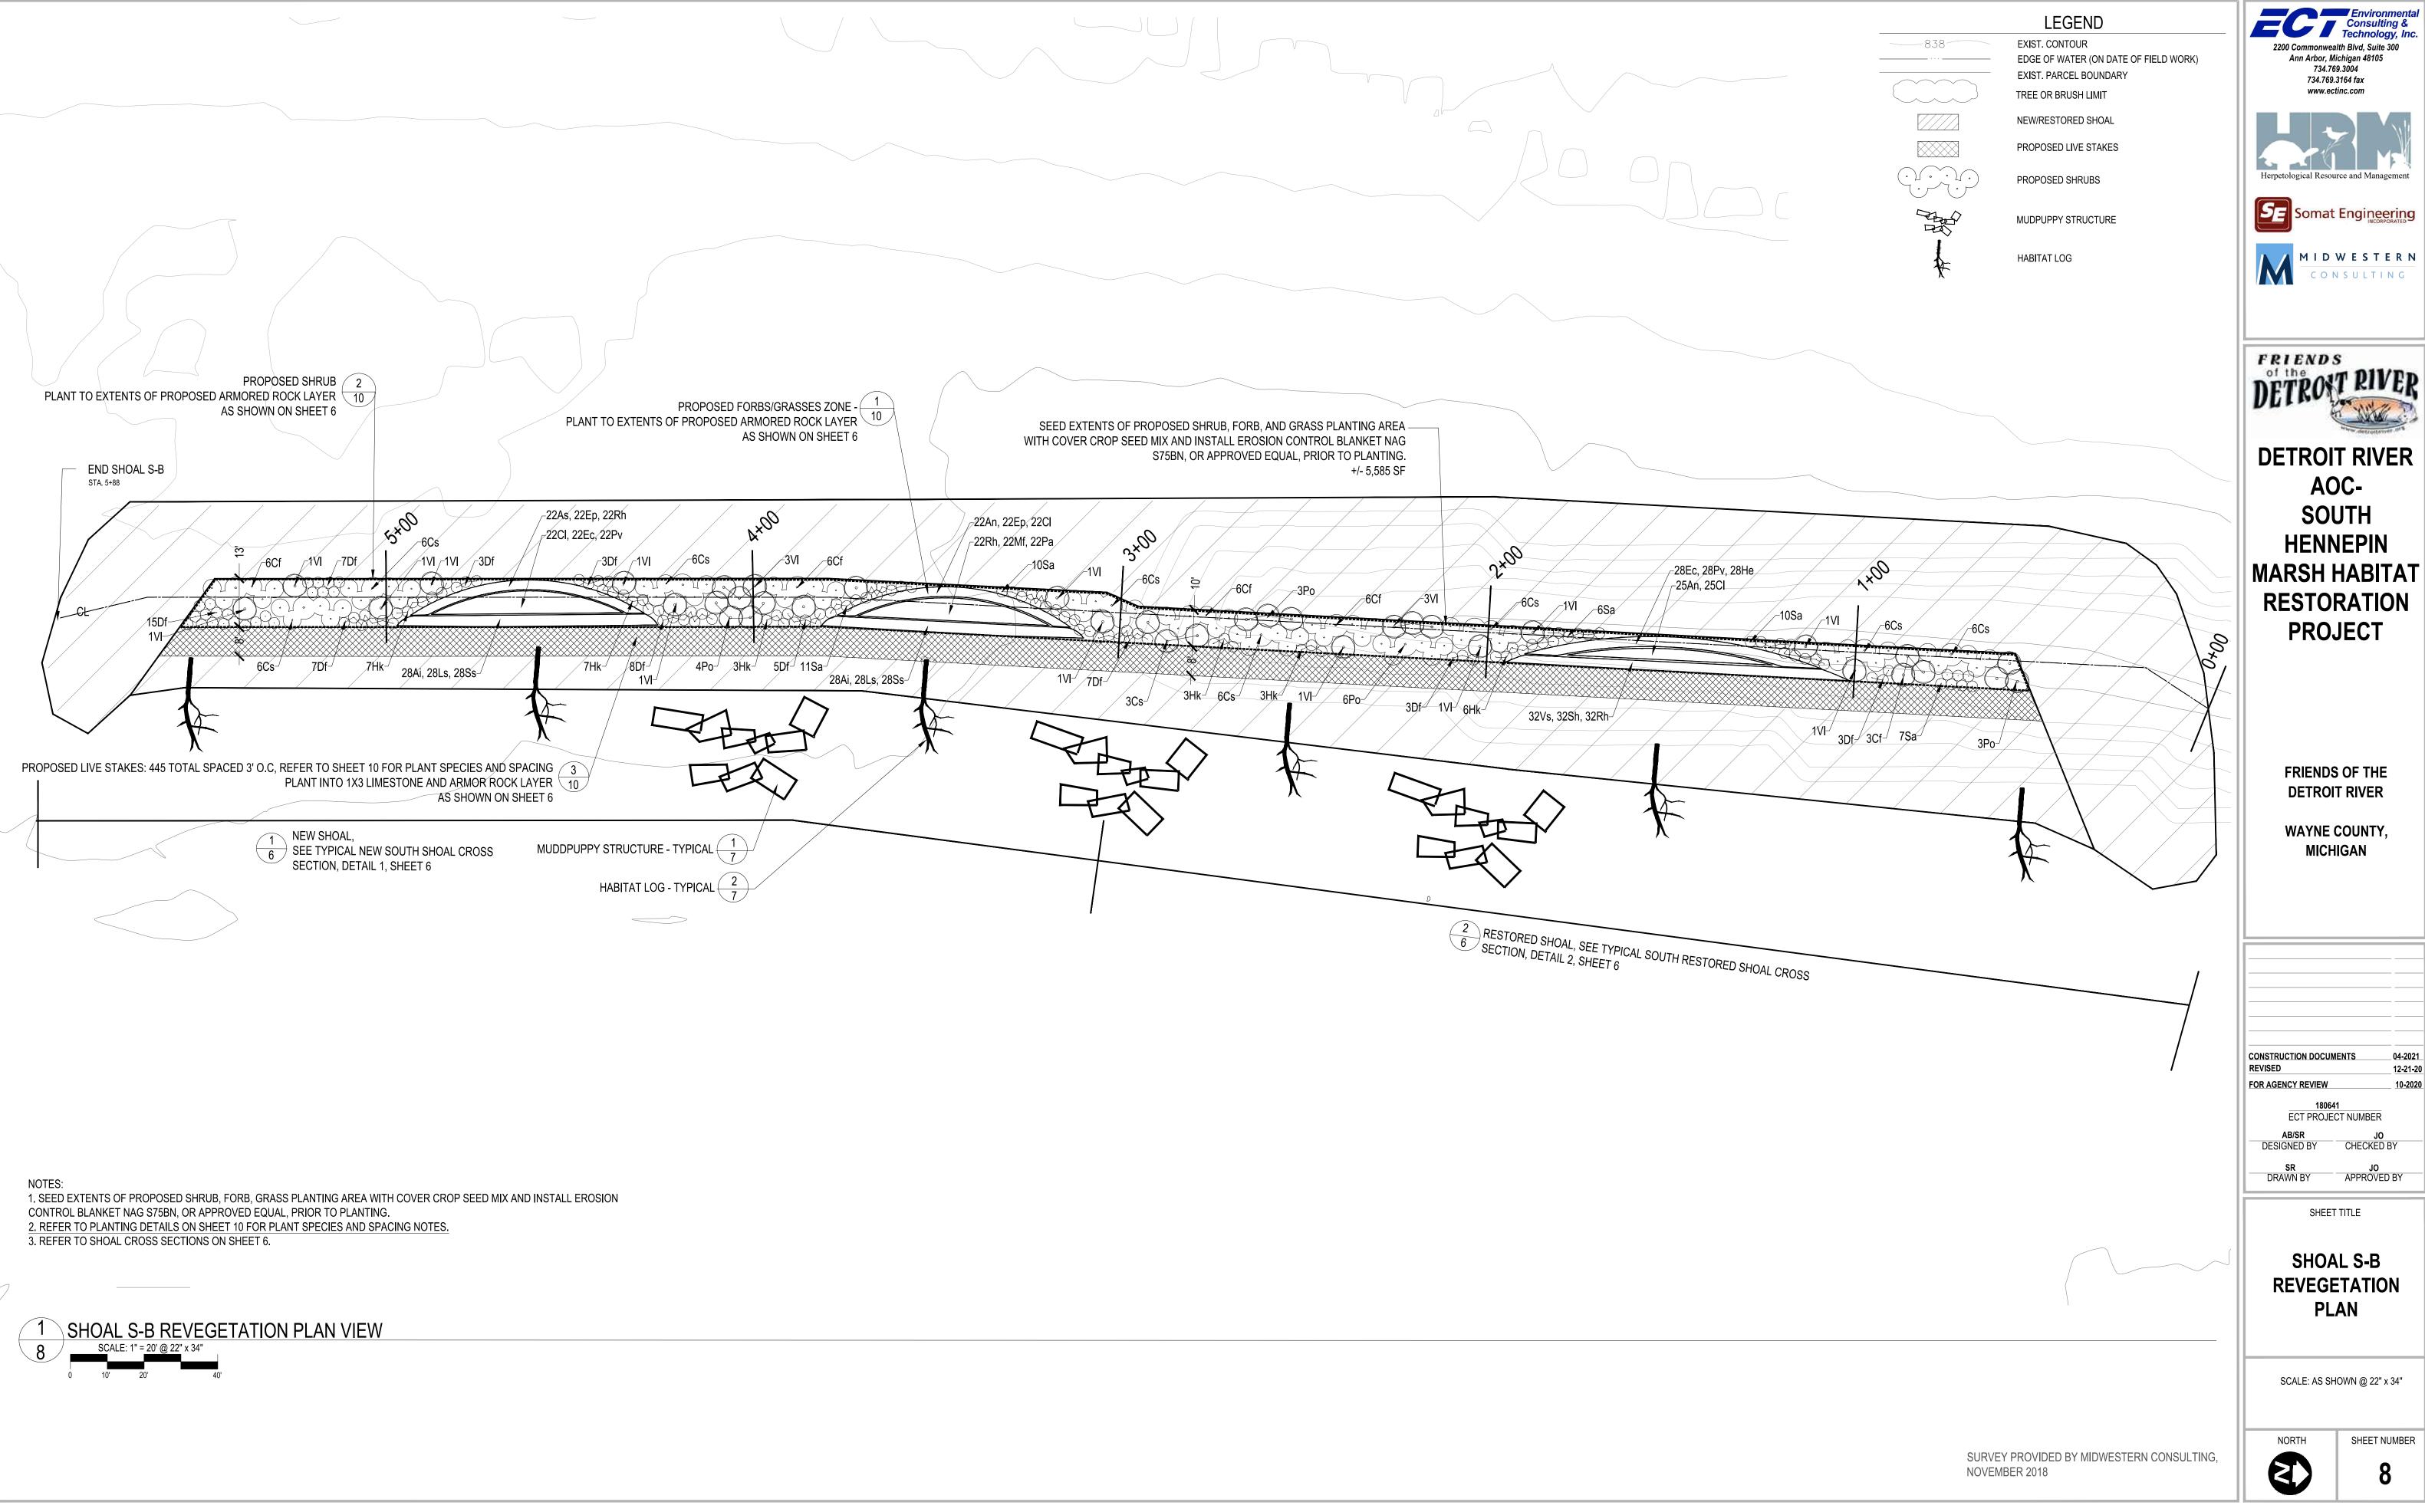

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FRIENDS OF THE DETROIT RIVER

WAYNE COUNTY, MICHIGAN

SHEET TITLE

DRAWN BY

APPROVED BY

SHOAL S-A REVEGETATION PLAN

SCALE: AS SHOWN @ 22" x 34"

NORTH

SHEET NUMBER

SURVEY PROVIDED BY MIDWESTERN CONSULTING, NOVEMBER 2018

REVEGETATION NOTES:

MAINTENANCE AND WARRANTY PERIOD:

- 1. MAINTENANCE PERIOD: ENSURE THAT ALL SHRUBS, SEEDING, AND HERBACEOUS PLANTS INSTALLED UNDER THIS CONTRACT WILL BE HEALTHY AND IN FLOURISHING CONDITION OF ACTIVE GROWTH FOR ONE (1) FULL GROWING SEASON (MAY THROUGH OCTOBER) FROM DATE OF PLANTING INSTALLATION ACCEPTANCE. THE CONTRACTOR SHALL RESPOND WITHIN TWO (2) WEEKS OF WRITTEN REQUESTS BY THE OWNER FOR REPLACEMENT OR REPAIR. IF THE CONTRACTOR FAILS TO RESPOND WITHIN THIS TIME, THE OWNER MAY PROCEED WITH REPLACEMENT WORK AND BILL THE CONTRACTOR.
- 2. WARRANTY PERIOD: ENSURE THAT ALL SHRUBS, SEEDING, AND HERBACEOUS PLANTS INSTALLED UNDER THIS CONTRACT WILL BE HEALTHY AND IN FLOURISHING CONDITION OF ACTIVE GROWTH FOR ONE (1) FULL GROWING SEASON (MAY THROUGH OCTOBER) FROM DATE OF MAINTENANCE PERIOD ACCEPTANCE. THE CONTRACTOR SHALL RESPOND WITHIN TWO (2) WEEKS OF WRITTEN REQUESTS BY THE OWNER FOR REPLACEMENT OR REPAIR. IF THE CONTRACTOR FAILS TO RESPOND WITHIN THIS TIME, THE OWNER MAY PROCEED WITH REPLACEMENT WORK AND BILL THE CONTRACTOR.
- 3. ALL DELAYS IN COMPLETION OF PLANTING OPERATIONS WHICH EXTEND THE PLANTING INTO MORE THAN ONE PLANTING SEASON SHALL EXTEND THE WARRANTY PERIOD CORRESPONDINGLY.
- 4. REPLACEMENTS: AS SOON AS WEATHER CONDITIONS PERMIT, REPLACE, WITHOUT COST TO OWNER, ALL DEAD PLANTS AND ALL PLANTS NOT IN A VIGOROUS, THRIVING CONDITION, AS DETERMINED BY THE ENGINEER DURING AND AT THE END OF THE MAINTENANCE AND WARRANTY PERIODS.
- 5. PATCHY OR BARE AREAS (IN EXCESS OF 8 SQUARE FEET) WHERE SEED MIX FAILED TO CREATE SUFFICIENT DENSITY OF COVER SHALL BE RESEEDED BY HAND AT THE RECOMMENDED APPLICATION RATE AT NO ADDITIONAL COST TO OWNER
- 6. INCORRECT MATERIALS: DURING WARRANTY PERIOD, REPLACE AT NO COST TO OWNER ALL PLANTS REVEALED AS BEING UNTRUE TO NAME. PROVIDE REPLACEMENTS OF A SIZE AND QUALITY TO MATCH THE PLANTED MATERIALS AT THE TIME THE MISTAKE IS DISCOVERED.
- 7. ALL PLANT STOCK SHALL BE WATERED BY THE CONTRACTOR TO ENSURE THE HEALTH AND VIGOR OF THE PLANTED MATERIALS. THE CONTRACTOR SHALL WATER AS NEEDED BASED ON NATURAL RAINFALL DURING THE MAINTENANCE AND WARRANTY PERIODS. WATERING SHALL CONTINUE SO SEEDLINGS DO NOT DRY OUT ONCE WATERING HAS BEGUN. THE WATERING SHALL BE DONE FROM SURFACE METHODS AT A PRESSURE NOT TO EXCEED THE INFILTRATION RATE OF THE SOIL, LIMITING RUNOFF DURING THE WATERING PERIOD. EACH AREA WILL BE WATERED WITH SUFFICIENT WATER TO COMPLETELY SATURATE THE ROOT ZONE. THE CONTRACTOR SHALL INSPECT ALL PLANTS FOR INSECT INFESTATION AND DAMAGE.
- 8. EROSION SHALL BE REPAIRED BY THE CONTRACTOR.
- 9. PROTECTION FROM EROSION IN NEWLY SEEDED AREAS IS THE RESPONSIBILITY OF THE CONTRACTOR. SAFETY FENCES AND/OR OTHER BARRIER METHODS WITH APPROPRIATE SIGNAGE MAY BE USED FOR ONE YEAR FROM COMPLETION OF CONSTRUCTION ACTIVITIES. ALL COSTS ASSOCIATED WITH THIS IS INCLUSIVE OF CONTRACTOR'S PRICING.
- 10. NOTIFY THE OWNER PRIOR TO AND FOLLOWING ANY MAINTENANCE ACTIVITY.
- 11. FINAL ACCEPTANCE OF WORK WILL BE SUBJECT TO ACCEPTANCE BY PROJECT MANAGER AND OWNER AT THE END OF WARRANTY

NATIVE PLANTINGS:

- 1. ALL PLANTS SHALL BE OF NATIVE PLANT MATERIAL OF GENOTYPES FROM THE NORTH CENTRAL STATES ONLY (IL, IN, IA, MI, OH), AND FROM A RECOGNIZED NURSERY OF THIS REGION. MICHIGAN SOURCES FOR SHRUBS, AND PLUGS SHALL BE LOCATED BEFORE BRANCHING OUT TO OTHER NORTH CENTRAL STATES. NATIVE PLANTINGS INCLUDE ALL SHRUBS AND PLUGS INSTALLED AS PART OF THIS PROJECT.
- 2. PLANTS SHALL BE NURSERY GROWN IN ACCORDANCE WITH GOOD HORTICULTURAL PRACTICES AND MUST MEET APPLICABLE REQUIREMENTS OF ICBN AND ICNCP. PLANTS SHALL BE SOUND, HEALTHY AND VIGOROUS, WELL BRANCHED AND DENSELY FOLIATED WHEN IN LEAF. PLANTS SHALL BE FREE OF DISEASE, INSECT PESTS, EGGS, OR LARVAE. PLANTS SHALL BE FREE OF KINKED, CIRCLING OR GIRDLING TRUNK SURFACE AND CENTER ROOTS, AND SHALL NOT BE ROOT-BOUND. RESPECT MAXIMUM STORAGE TIMES FOR PLANT STOCK.
- 3. NATIVE PLANTING AREAS SHALL BE INSTALLED AFTER MAY 15 (WHEN SOIL IS FREE OF FROST AND IN WORKABLE CONDITION), BUT BEFORE JUNE 30 OR AFTER SEPT. 1 BUT BEFORE OCTOBER 30 OR AS APPROVED BY THE LANDSCAPE ECOLOGIST
- 4. FURNISH PLANT SPECIES AND SIZES AS INDICATED ON THE PLANS. PLANT STOCK SHALL BE TRUE TO THEIR NAME (GENUS AND SPECIES), AS SPECIFIED. CULTIVARS AND SPECIMENS SHALL NOT BE USED WITHOUT PRIOR APPROVAL BY LANDSCAPE ECOLOGIST
- 5. NATIVE PLANTINGS TO BE INSTALLED PER DETAILS. REMOVE ALL CONTAINERS, TAGS AND PACKAGING MATERIAL AND DISPOSE OF LEGALLY OFF-SITE.
- 7. WATER PLANT STOCK IMMEDIATELY AFTER PLANTING SUCH THAT ROOT ZONE IS THOROUGHLY SOAKED. CONTRACTOR SHALL BE
- RESPONSIBLE TO KEEP PLUGS ADEQUATELY WATERED, IF NECESSARY, TO ENSURE THEIR SURVIVAL
- 8. INSTALL EROSION CONTROL BLANKET AFTER SEEDING, BUT PRIOR TO PLANTING. EROSION CONTROL BLANKET SHALL BE INSTALLED WHERE THE CONTRACTOR FEELS IT NECESSARY TO STABILIZE THE SITE AT NO ADDITIONAL COST TO THE OWNER.

- 1. SEED SHALL BE FRESH, CLEAN, NEW SEED OF NATIVE PLANT MATERIAL OF GENOTYPES FROM THE NORTH CENTRAL STATES ONLY
- (IL, IN, IA, MI, OH), AND FROM A RECOGNIZED NURSERY OF THIS REGION REFER TO SPECIFICATION 02930.
- 2. SEED AREAS SHALL BE SEEDED AFTER MAY 1, (WHEN SOIL IS FREE OF FROST AND IN WORKABLE CONDITION), BUT BEFORE JUNE 30 OR AFTER OCTOBER 1, BUT BEFORE NOVEMBER 30 (OR PRIOR TO FREEZE-UP) OR AS APPROVED BY THE LANDSCAPE ECOLOGIST. SEEDBED PREPARATION: PRIOR TO SOWING SEED, LIGHTLY SCARIFY SO THAT THE BED IS SMOOTH AND FREE OF LARGE CLUMPS. SEED BED SHALL BE FIRM. BUT NOT COMPACT. SEED IMMEDIATELY AFTER SCARIFYING AND ENSURE GOOD SOIL TO SEED CONTACT. DO NOT FERTILIZE.
- 4. DO NOT SOW SEED WHERE STANDING WATER IS PRESENT.

RE-SEED ALL DISTURBED AREAS TO PRE-EXISTING CONDITIONS.


5. SOW PROPOSED SEED AT A SPECIES RATE OF POUNDS PER ACRE INDICATED ON THE DRAWING AND PER SUPPLIERS RECOMMENDATIONS. LIGHTLY RAKE TO INCORPORATE SEED INTO SOIL. DO NOT COVER SEED MORE THAN 1/4 INCH WITH SOIL. 6. CONTRACTOR SHALL REPAIR DAMAGED VEGETATION AND AERATE SOIL OVER ROOT ZONE OF NEGATIVELY IMPACTED VEGETATION.

EXISTING SITE CONDITIONS:

- 1. CONTRACTOR SHALL BECOME FAMILIAR WITH ALL EXISTING SITE CONDITIONS PRIOR TO STARTING WORK.
- 2. THE CONTRACTOR UNDERSTANDS AND ACKNOWLEDGES THAT THE PERFORMANCE OF THE WORK IS REQUIRED WITHIN A RIVER SYSTEM AND FLOODPLAIN.
- 3. THE CONTRACTOR SHALL BE FULLY AWARE OF THE DETROIT RIVER HYDROLOGY AND CURRENT WEATHER CONDITIONS SO THAT WORK IN PROGRESS CAN BE SECURED AND PROTECTED, SO THAT SAFE JOB SITE WORKING CONDITIONS ARE MAINTAINED, AND SO THAT SOIL EROSION IS MINIMIZED DURING AND FOLLOWING A RAIN EVENT.
- 4. THE CONTRACTOR ACKNOWLEDGES THAT DELAYS IN THE START OF OR COMPLETION OF WORK DUE TO TYPICAL SEASONAL RAINFALL AND DUE TO TYPICAL PERIODIC HIGH FLOWS IN THE ROUGE RIVER SHALL NOT CONSTITUTE A BASIS FOR ANY EXTENSION OF TIME OR DAMAGES. IF THE CONTRACTOR SHALL BE UNAVOIDABLY DELAYED IN BEGINNING OR FULFILLING THIS CONTRACT BY REASONS OF EXCESSIVE STORM OR FLOODS THE CONTRACTOR SHALL HAVE NO VALID CLAIM FOR DAMAGES, BUT THEY SHALL IN SUCH CASE BE ENTITLED TO AN EXTENSION OF TIME AS THE ENGINEER SHALL ADJUDGE TO BE JUST AND REASONABLE; PROVIDED THAT FORMAL CLAIM FOR AN EXTENSION OF TIME IS MADE IN WRITING BY THE CONTRACTOR WITHIN ONE WEEK OF THE ALLEGED DELAY.

ENSURE THAT ROOTS ARE POINTING DOWNWARD IN THE HOLE. WHEN CLOSING PLANTING HOLE, ENSURE NO AIR POCKETS ARE LEFT IN HOLE. WATER TO SATURATE BACKFILL MATERIAL WITHIN 1 HOUR OF PLANTING ROOT COLLAR SQUARE TO FINISH GRADE-PROVIDE 3" SOIL SAUCER AROUND EACH PLANT BACKFILL WITH EX. SOIL OPEN PLANTING PIT TO BE TWICE THE SIZE OF PLUG ROOT



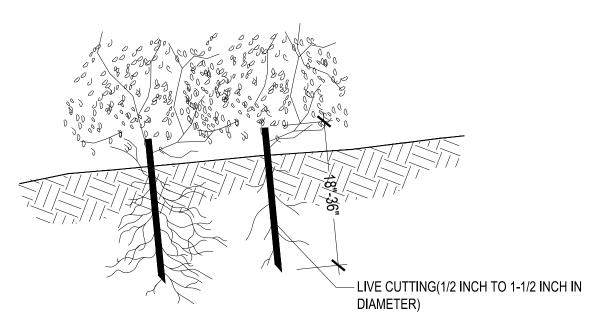

NOTES:

- 1. INSTALL AS DIRECTED BY LANDSCAPE ECOLOGIST, DURING FIRST DORMANT SEASON FOLLOWING SEEDING.
- DO NOT ALLOW LIVE STAKES TO DRY OUT, SOAK PRIOR TO INSTALLATION PER SUPPLIERS RECOMMENDATION. 3. ROOTED/LEAFED CONDITION OF THE LIVING PLANT MATERIAL IS NOT REPRESENTED AT THE THE TIME OF
- INSTALLATION. 4. INSTALL LIVE STAKES AT RIGHT ANGLES PUSH INTO THE GROUND BY HAND. DRIVE A PILOT HOLE USING A DEAD **BLOW HAMMER AS NEEDED.**
- 5. BURY FOUR-FIFTHS OF THE STAKE IN THE GROUND. AND FIRMLY PACK AROUND IT. ORIENT THE BUDS UP. 6. INSTALL STAKE ROWS 1.5' APART AND INSTALL LIVE STAKES AT 3' SPACING ALONG ROWS. STAGGER ROWS TO CREATE TRIANGULAR SPACING PATTERN.
- 7. SPECIES LIST ON THIS SHEET. LISTED SPECIES ARE TO BE EQUALLY REPRESENTED.
- 8. PLANT ALONG LENGTH OF SHOAL AS SHOWN IN DRAWINGS DISTRIBUTING SPECIES IN 9-12 PLANT GROUPINGS
- TO MAXIMIZE DIVERSITY.

LIVE STAKE DETAIL ✓ NOT TO SCALE

PLANT LIST: (OR APPROVED EQUALS)

145 Salix discolor

Symbol	Quantity	Scientific Name	Common Name	Size	*Cont.	Spac
FORBS						
Ai	106	Asclepias incarnata	Swamp Milkweed	Plug	Plug	18"
As	22	Asclepias syriaca	Common Milkweed	Plug	Plug	18"
An	93	Aster novae-angliae	New England Aster	Plug	Plug	18"
Cl	91	Coresopsis lanceolata	Lanceleaf Coresopsis	Plug	Plug	18"
Ep	90	Echinacea purpurea	Purple Coneflower	Plug	Plug	18"
Ec	69	Euphorbia corollata	Flowering Spurge	Plug	Plug	18"
He	50	Heliopsis helianthoides	False Sunflower	Plug	Plug	18"
Ls	56	Liatris spicata	Blazing Star	Plug	Plug	18"
Mf	22	Monarda fistulosa	Beebalm	Plug	Plug	18"
Pv	50	Pycnanthemum virginianum	Common Mountain Mint	Plug	Plug	18"
Rh	98	Rudbeckia hirta	Blackeyed Susan	Plug	Plug	18"
Vs	82	Verbena stricta	Hoary Vervain	Plug	Plug	18"
GRASSES						
Pa	41	Panicum virgatum	Switchgrass	Plug	Flat	18"
Sh	32	Sporobolus heterolepis	Prairie Dropseed	Plug	Flat	18"
Ss	106	Schyzachyruim scoparium	Little Bluestem	Plug	Flat	18"
Symbol	Quantity	Scientific Name	Common Name	Size	Cont.	Spac
SHRUBS						
Cf	57	Cornus foemina	Gray Dogwood	Min. 30" ht.	5 Gal.	5' 0
Cs	105	Cornus sericea	Red-oisier Dogwood	Min. 30" ht.	5 Gal.	5' 0
Df	117	Dasiphora fruticosa	Shrubby Cinquefoil	Min. 24" ht.	5 Gal.	3' 0
Hk	70	Hypericum kalmianum	Kalm's St. John's Wort	Min. 24" ht.	5 Gal.	3' 0
Po	52	Physocarpus opulifolius	Common Ninebark	Min. 30" ht.	5 Gal.	5' 0
Sa	89	Spiraea alba	Meadowsweet	Min. 24" ht.	5 Gal.	3' 0
VI	40	Viburnum lentago	Nannyberry	Min. 30" ht.	5 Gal.	5' 0
	Quantity	Scientific Name	Common Name	Size	Cont.	Spac
LIVE STAK	ES					
	145	Cornus foemina	Gray Dogwood	Min. 36" ht.		3' 0
	145	Cornus sericea	Red-oisier Dogwood	Min. 36" ht.		3' 0
	145	Physocarpus opulifolius	Common Ninebark	Min. 36" ht.		3' 0
	145	Hypericum kalmianum	Kalm's St. John's Wort	Min. 36" ht.		3' 0
	145	Salix exigua	Sandbar Willow	Min. 36" ht.		3' c


Pussy Willow

Min. 36" ht.

3' o.c.

PLANT ALL SHRUBS VERTICAL

PRUNE ALL DEAD OR DAMAGED BRANCHES

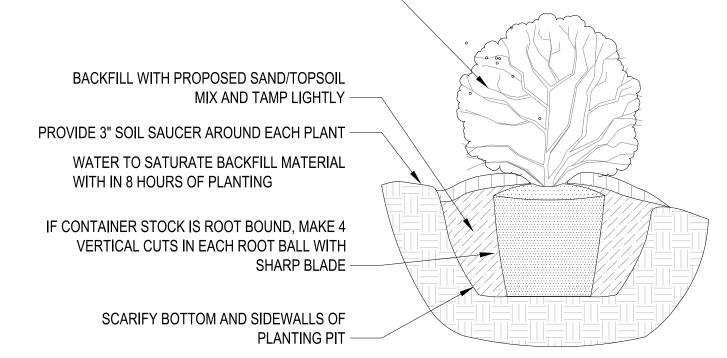

SHRUB PLANTING DETAIL ✓ NOT TO SCALE

PLANT LIST AND SEED MIX

- 1. SEED EXTENTS OF PROPOSED PLANTING AREA WITH COVER CROP SEED MIX, AND INSTALL EROSION CONTROL BLANKET: NAG S75BN, OR APPROVED EQUAL 2. INSTALL PROPOSED FORBS, GRASSES, SHRUBS, AND LIVE STAKES AS DIRECTED BY LANDSCAPE ECOLOGIST, DURING FIRST GROWING SEASON FOLLOWING
- 3. SPECIES LIST AS SHOWN ON THIS SHEET, OR APPROVED EQUAL.
- 4. PLANT FORBS/GRASSES AT 18" O.C. IN STAGGERED ROWS ALONG LENGTH OF SHOAL IN ZONES AS SHOWN AND NOTED ON DRAWINGS, DISTRIBUTE SPECIES EVENLY
- THROUGHOUT DESIGNATED ZONES, IN 5-9 PLANT GROUPINGS TO MAXIMIZE DIVERSITY.
- 5, PLANT SHRUBS AT 3'-5' O.C. ALONG LENGTH OF SHOAL IN ZONES AS SHOWN IN DRAWINGS 6. SHRUB SIZE SHALL BE 5 GALLON SIZE AS AVAILABLE, OR APPROVED EQUAL
- 7. FORB AND GRASS SIZE SHALL BE PLUG SIZE AS AVAILABLE, OR APPROVED EQUAL

COVER CROP SEED MIX: 10,985 SF (+/- 0.25 ACRES TOTAL

Annual Cover Crop	
8 oz./1000 s.f. or 15 lbs./acre	
Scientific Name	Common Name
Avena sativa	Seed Oats
Lolium multiflorum	Annual Rye

Ann Arbor, Michigan 48105 734.769.3004 www.ectinc.com









AOC-SOUTH HENNEPIN **MARSH HABITAT** RESTORATION **PROJECT**

> FRIENDS OF THE **DETROIT RIVER**

WAYNE COUNTY, **MICHIGAN**

CONSTRUCTION DOCUMENTS 04-2021 FOR AGENCY REVIEW ECT PROJECT NUMBER CHECKED BY DESIGNED BY

SHEET TITLE

REVEGETATION

DETAILS

DRAWN BY

APPROVED BY

SCALE: AS SHOWN @ 22" x 34"

